

- CONSTRUCTION NOTIES

 GENERAL LOCATION OF UTILITIES IS SHOWN ON THE PLANS. THEY ARE SHOWN FOR GENERAL INFORMATION ONLY AND DO NOT DESIGNATE EXACT UTILITY LOCATIONS. UTILITIES SHOWN MAY NOT BE INCLUSIVE OF ALL UTILIES THAT EXIST.

 IT IS THE CONTRACTOR'S RESPONSIBILITY TO NOTIFY "DIG LINE" PRIOR TO EXCLAYATING AND TO COMPLY WITH IDAPH CODE SECTION 55-220" AND ALL OTHER APPLICABLE LAWS AND REGULATION REGARDING THE PROTECTION OF UNDERGROUND UTILITIES.

- AMINDE TO THEM.

 HE CONTRACTOR SHALL NOTIFY ALL CONCERNED UTILITY OFFICES AT LEAST 48 HOURS IN
 DVANCE OF CONSTRUCTION OPERATIONS IN WHICH A UTILITY AGENCY'S FACILITIES MAY BE
- ADVANCE OF CONSTRUCTION OPERATIONS IN WHICH A UTILITY AGENCYS FACILITIES MAY BE INVOLVED THIS SHALL INCLUDE BUT NOT BE LIMITED TO, IRRIGATION WATER, CULINARY WATER, SANITARY SEWER, TELEPHONE, GAS, AND ELECTRIC.

 THE CONTRACTOR SHALL BE RESPONSIBLE FOR ANY AND ALL CHANGES TO, OR RE-CONNECTION TO, PUBLIC UTILITY FACILITIES ENCOUNTEED OR INTERRIPTED DURING EXECUTION OF THE WORK AND ALL COSTS RELATED ITHERETO SHALL BE BORNE BY THE CONTRACTOR.

 CONTINUOUS SERVICE—UNLESS OTHERWISE REQUIRED IN THE CONTRACTOR COUNTINUOUS SERVICE THROUGHOUT THE ENTIRE CONTRACT DECOUNTED. SHALL BE MAINTAINED IN CONTINUOUS SERVICE THROUGHOUT THE ENTIRE CONTRACT DECOUNTED.

- RECONSTRUCTION.
 DIMENSIONS TO, OR COORDINATES FOR, MANHOLES, PIPELINES, ETC. ARE TO CENTERLINE UNLESS OTHERWISE NOTED.
 ELEVATIONS SHOWN ARE TO THE FINISHED SURFACE OR PIPE INVERT UNLESS OTHERWISE NOTED.
 ALL NEW UTILITY LINES ARE TO BE LOCATED AS SHOWN, ON THE PLANS UNLESS RELOCATED IN THE FIELD BY THE ENDINGER TO AVIOID INTERPRENENCE WITH OTHER ASPECTS OF THE PROJECT.
 WHILE GROUNDWATER IS NOT EXPECTED, THE CONTRACTOR SHALL INVESTIGATE GROUNDWATER CONDITIONS PRIOR TO CONSTRUCT IN AND SHALL BE RESPONSIBLE FOR ANY DEWATERING NECESSARY TO CONSTRUCT THE PROJECT.
- M. UTILITY INSTALLATION SHALL CONFORM WITH TETON COUNTY H&SGDC AND WITH THE ISPWC
- N. EACH LOT WILL HAVE AN INDIVIDUAL SUBSURFACE WASTEWATER DISPOSAL SYSTEM PER DIS 7 HEALTH DEPARTMENT

ш	/ HEALITI DEPARTMENT		
ı	BUILDING SEWER		
ш	MATERIAL	DIVE COD SE OD ARC COURDING 40	

90	PROPERTY LINES	5 FT.
500	BUILDING FOUNDATIONS	
200	POTABLE WATER PIPES	25 FT.
13	SURFACE WATER	50 FT.
183	SETBACKS FOR ABSORPTION SYSTEM	
350	WELLS	
200	PROPERTY LINES	
614	BUILDING FOUNDATIONS	
20	POTABLE WATER PIPES	
2.	SEPTIC TANKS	6 FT.
34	SURFACE WATER	50 FT.
22	GROUNDWATER AND SOILS	
	GROUNDWATER DEPTH (BY EXPLORATION PIT OBSERVED BY HEALTH DEPT.)	> 10 FT. BGS
	SOIL TEXTURAL CLASSIFICATION 0-4' BGS (PER DISTRICT 7 HEALTH DEPT.)	A-2b
	SUBSPOUR CORPECTION (ONE SUBSPOUR)	D.4

 SOIL DESIGN SUBGROUP

 A-2
 B-1
 B-2
 C-1

MODIFIE	D EFFECTIVE SOIL DEPTH TO IMPERMEABLE LAYER ALLOWED (TO	GM TABLE 2-6)
a.	SITE SLOPE SEPTIC SYSTEM, E TO W	10%
b. :	SITE SLOPE DRAIN FIELD, E TO W	0-
C.	LOT SIZE AREA	<= 1 AC
d.	POTENTIAL MODIFIED EFFECTIVE DEPTH	4.0 FEET - NO MODIFICATI
EFFECTI	VE SEPARATION DISTANCE TO PERMANENT WATER ALLOWED	200 FE
a.	REDUCTION (VERTICAL DISTANCE TO WATER > 25 FEET - NO)	0 FE
i.	RESULTING SEPARATION TO PERMANENT WATER	200 FE
ii.	SEPARATION FOR LINED POND	100 FE
CULIN	ARY WATER	

- . EACH STRUCTURE WILL HAVE AN INDIVIDUAL WELL UNDER THE DOMESTIC EXEMPTION ALLOWED BY THE STATE OF IDAHO. PRIVATE UTILITIES
- FALL RIVER ELECTRIC IS THE POWER PROVIDER FOR ELECTRICITY AND WILL DESIGN THE POWER DISTRIBUTION SYSTEM
- GAS WILL BE PROVIDED BY THE INDIVIDUAL HOMEOWNER THROUGH THE INSTALLATION OF A PROPANE TANK.

EUSTACHY-WYSONG RANCH PLAN SITE UTILITY

SHEET NO: C-105 DATE: MARCH 2023

PAGE NO:


EUSTACHY-WYSONG


Engineering

EUSTACY-WYSONG LLC EUSTACHY-WYSONG RANCH

SUBDIVISION DESIGN

MARCH 2024

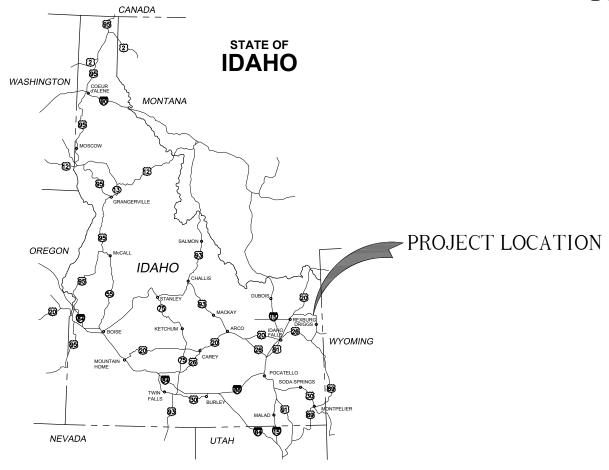

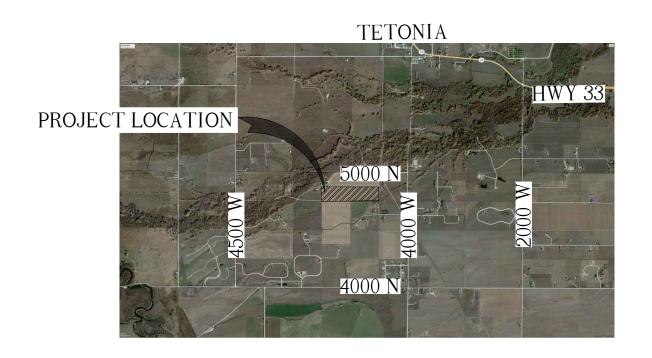

VICINITY MAP

LOCATION MAP

PRELIMINARY ISSUE NOT FOR CONSTRUCTION

PROJECT NUMBER 01-21-0060



CIVILIZE, PLL
Management and Engineerin

LC DESIGNED B. CROWTHER APPROVED B. CROWTHER B. CROWTH

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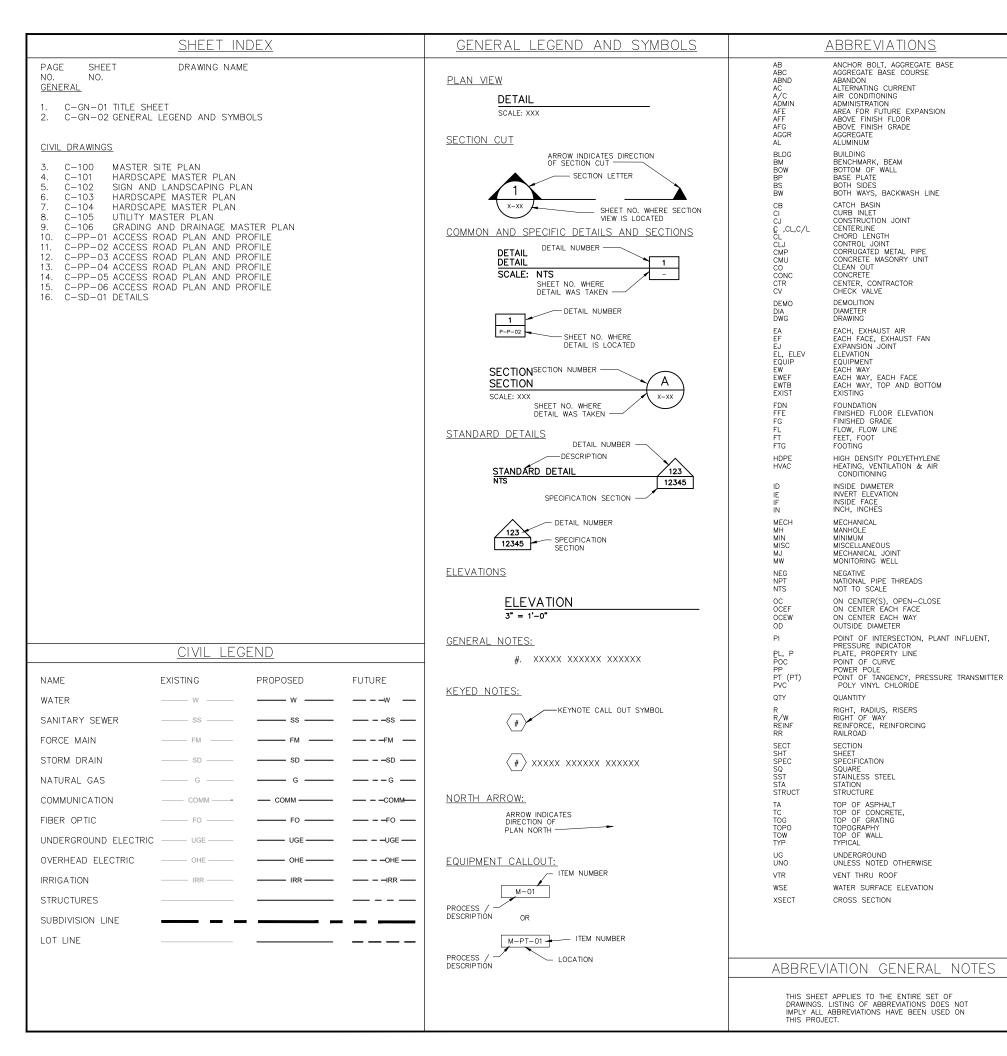
EUSTACHY-WYSONG RANCH

SHEET NO:

C-GN-01

DATE:
MARCH 2023

PAGE NO:



GENERAL NOTES

A THE ENGINEERING DESIGNS ON THESE PLANS ARE ONLY APPROVED BY THE OWNER IN SCOPE AND NOT THE OWNER.

- B. THE CONTRACTOR SHALL COORDINATE WORK SCHEDULES WITH THE OWNER'S REPRESENTATIVE TO PREVENT ANY CONFLICTING WORK CONDITIONS.
- C. LOCATIONS, ELEVATIONS AND DIMENSIONS OF EXISTING UTILITIES, STRUCTURES AND OTHER FEATURES ARE SHOWN ACCORDING TO THE BEST INFORMATION AVAILABLE AT THE TIME OF THE PREPARATION OF THESE PLANS. BUT DO NOT PURPORT TO BE ABSOLUTELY CORRECT AND ARE APPROXIMATE. THE CONTRACTOR SHALL BE RESPONSIBLE FOR VERIFYING LOCATIONS, ELEVATIONS AND DIMENSIONS OF ALL EXISTING UTILITIES, STRUCTURES AND OTHER FEATURES AFFECTING THIS WORK AND AVOIDING DAMAGE
- D. (**) INDICATES DIMENSIONS, LOCATIONS OR ELEVATIONS TO BE FIELD VERIFIED.
- F THE CONTRACTOR SHALL VERIEY ALL DIMENSIONS BEFORE STARTING WORK AND SHALL IMMEDIATELY NOTIFY THE OWNER OF ANY DISCREPANCIES. ADDITIONALLY, ALL OMISSIONS OR CONFLICTS BETWEEN THE VARIOUS ELEMENTS OF THE WORKING DRAWINGS AND/OR SPECIFICATIONS SHALL BE BROUGHT TO THE ATTENTION OF THE ENGINEER BEFORE PROCEEDING WITH ANY WORK INVOLVED.
- F. UNLESS DETAILED, SPECIFIED OR INDICATED OTHERWISE, CONSTRUCTION SHALL BE AS INDICATED IN THE APPLICABLE TYPICAL DETAILS AND GENERAL NOTES. TYPICAL DETAILS ARE MEANT TO APPLY EVEN THOUGH NOT REFERENCED AT SPECIFIC LOCATIONS OR ON SPECIFIC DRAWINGS
- G. SCREENING OR SHADING OF WORK IS USED TO INDICATE EXISTING COMPONENTS OR TO DE-EMPHASIZE PROPOSED IMPROVEMENTS TO HIGHLIGHT SELECTED TRADE WORK. REFER TO CONTEXT OF EACH DRAWING FOR USAGE.
- H. CONTRACTOR SHALL PREPARE AND FURNISH TO THE OWNER A SET OF AS-BUILT DRAWINGS AT THE COMPLETION OF THE PROJECT
- L CONTRACTOR SHALL KEEP ALL CONSTRUCTION FOUIPMENT AT LEAST 10' FROM EXISTING OVERHEAD POWER LINES. IF THIS IS NOT FEASIBLE, CONTACT THE UTILITY OWNER TO INSTALL A TEMPORARY PROTECTIVE COVERING ON THE POWER LINES.
- J. DRAWINGS SHOWING GENERAL SYMBOLOGY ARE STANDARD DRAWINGS. ALL SYMBOLS ARE NOT
- K. SEE PROJECT EQUIPMENT AND PIPING SYSTEMS DRAWING FOR SYMBOLS AND ABBREVIATIONS SPECIFIC
- L. IF PLAN AND SECTION, OR DETAIL CALL-OUT AND DETAIL ARE SHOWN ON SAME DRAWING, DRAWING NUMBER IS REPLACED BY A LINE (-).
- M. ALL DESIGN, CONSTRUCTION, AND INSPECTION SHALL BE IN CONFORMANCE WITH THE 2012 INTERNATIONAL BUILDING CODE.
- N. DRAWINGS INDICATE THE FINISHED PRODUCT. THEY DO NOT INDICATE A METHOD OF CONSTRUCTION. CONTRACTOR SHALL TAKE ALL PRECAUTIONS NECESSARY TO PROTECT NEW AND EXISTING STRUCTURES DURING CONSTRUCTION. SUCH PRECAUTIONS SHALL INCLUDE, BUT NOT BE LIMITED TO, BRACING, SHORING FOR CONSTRUCTION EQUIPMENT, ETC.
- O THE CONTRACTOR SHALL BE RESPONSIBLE FOR COMPENSATING THE OWNER FOR ANY CHANGES MADE AS A RESULT OF A DEVIATION FROM THE CONTRACT DOCUMENTS SPECIFICATIONS, FAULTY MATERIALS,
- OPTIONS ARE FOR THE CONTRACTORS CONVENIENCE. THE CONTRACTOR SHALL BE RESPONSIBLE FOR COORDINATING ALL REQUIRED DESIGN CHANGES. COST ASSOCIATED WITH ANY DESIGN WORK INITIATED BY THE OPTION SHALL BE BORN BY THE CONTRACTOR.
- Q. CONTRACTOR SHALL BE RESPONSIBLE FOR SAFETY AND PROTECTION WITHIN AND ADJACENT TO THE
- R. OBSERVATION VISITS TO THE JOB SITE BY FIELD REPRESENTATIVES OF THE ENGINEER SHALL NEITHER
- S. IT IS THE RESPONSIBILITY OF THE CONTRACTOR TO NOTIFY THE APPROPRIATE UTILITY COMPANIES THE RESPONSIBILITY OF THE CONTRACTOR TO NOTIFY THE APPROPHATE UTILITY COMPANIES WHEN CONSTRUCTION MIGHT INTERFERE WITH NORMAL OPERATION OF ANY UTILITIES. IT SHALL ALSO BE THE CONTRACTOR'S RESPONSIBILITY TO CONTACT DIGLINE OF IDAHO 1-800-342-1585 OR 811 TO HAVE THE APPROPRIATE UTILITY COMPANIES LOCATE ANY UTILITY LOCATIONS WHICH MIGHT INTERFERE WITH CONSTRUCTION. THE CONTRACTOR SHALL BE RESPONSIBLE FOR MAINTAINING SERVICE OF EXISTING UTILITIES AND FOR RESTORING ANY UTILITIES DAMAGED DUE TO CONSTRUCTION AT NO ADDITIONAL COST TO THE OWNER.
- CONTINUOUS SERVICE UNLESS OTHERWISE REQUIRED IN THE CONTRACT DOCUMENTS, ALL UTILITIES, BOTH UNDERGROUND AND OVERHEAD, SHALL BE MAINTAINED IN CONTINUOUS SERVICE THROUGHOUT THE ENTIRE CONTRACT PERIOD.
- U. ACCIDENTAL INTERRUPTION OF SERVICE IN THE EVENT OF INTERRUPTION OF OTHER UTILITY SERVICES AS A RESULT OF ACCIDENTAL BREAKAGE, THE CONTRACTOR SHALL PROMPTLY NOTIFY THE APPROPRIATE RESPONSIBLE AUTHORITY. THE CONTRACTOR SHALL THEN COOPERATE WITH THAT AUTHORITY TO RESTORE SERVICE AS SOON AS POSSIBLE.
- V. TEMPORARY INTERRUPTION AND RELOCATION IF THE CONTRACTOR DESIRES TO DISRUPT ANY UTILITY OR APPURTENANCE, THE CONTRACTOR SHALL MAKE THE NECESSARY ARRANGEMENTS AND AGREEMENTS WITH THE OWNER OR OPERATOR OF THE RESPECTIVE UTILITY AND SHALL BE COMPLETELY RESPONSIBLE FOR ALL COSTS CONCERNED WITH THE DISRUPTION AND RECONSTRUCTION.

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EUSTACHY-WYSONG SHEET NO C-GN-02

PAGE NO:

3/14/24 3 MARCH 2023



C-100 MASTER PLAN

GENERAL INFORMATION, JURISDICTION, ZONING

JURISDICTION. .TETON COUNTY SUBDIVISION REGULATIONS TETON COUNTY, IDAHO IMPACT AREA.

PROPOSED DEVELOPMENT DESCRIPTION

AREA OF PARCEL RESIDENTIAL, SINGLE FAMILY AVERAGE DENSITY RESIDENTIAL LOTS ... PROPOSED ZONING.....6.00 ACRES/LOT RURAL RESIDENTIAL 2.5

APPLICABLE CODES

...AUGUST 24, 2012SEPT 15, 2011 ...AUGUST 14, 1995TETON COUNTYTETON COUNTY

TETON COUNTY AGRICULTURAL/RURAL RESIDENTIAL 2.5 STANDARDS

PURPOSE: THE PURPOSE OF THIS DISTRICT IS TO DESIGNATE AND PROVIDE OPPORTUNITIES FOR THE DEVELOPMENT OF RESIDENTIAL LAND USE ON MARGINAL AGRICULTURAL LAND. IMPACT AREA..... DESIGN REVIEW OVERLAY . OVERLAY ZONE

ALLOWED USES
SINGLE-FAMILY RESIDENTIAL.
MOBILE HOME, MODULAR......
DWELLING ACCESSORY UNIT.2.5 ACRES

MINIMUM LOT SIZE..... MINIMUM LOT WIDTH... BUILDING SETBACKS
FRONT YARD.
REAR YARD.
SIDE YARD.
TETON RIVER.
STREAM, CREEK.
IRRIGATION DITCH.

...30' MIN ...40' MIN ...30' MIN ..100' MIN ...50' MIN ...15' MIN

Engineering


EUSTACHY-WYSONG LLC

MASTER SITE PLAN

EUSTACHY-WYSONG RANCH

SHEET NO: C-100

DATE: MARCH 2023 PAGE NO:

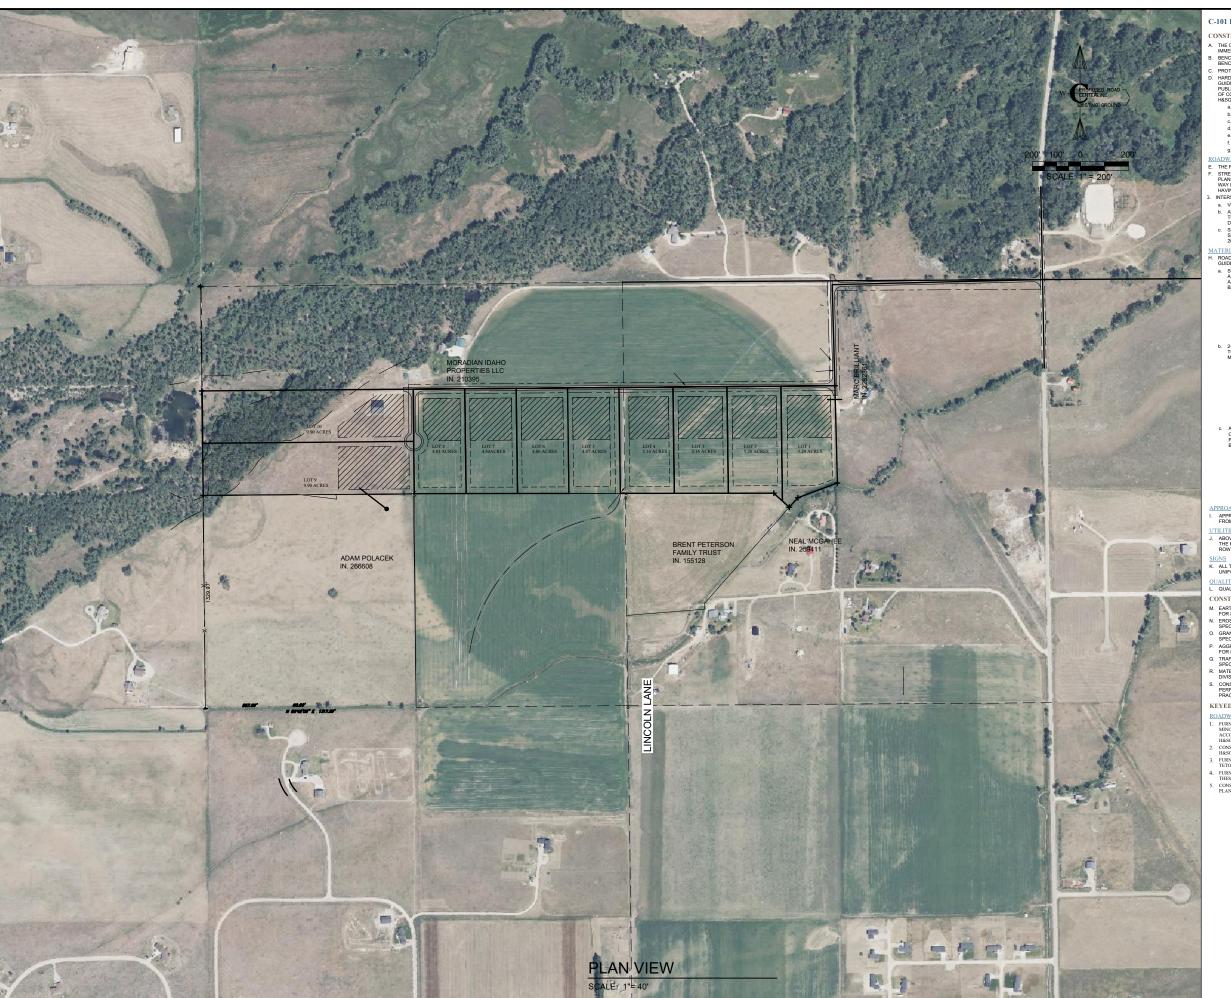

C-101 HARDSCAPE PLAN

CONSTRUCTION NOTES

- THE CONTRACTOR SHALL VERIFY ALL DIMENSIONS BEFORE STARTING WORK AND SHALL IMMEDIATELY NOTIFY THE OWNER OF ANY DISCREPANCIES.

- IMMEDIATELY NOTIFY THE OWNER OF ANY DISCREPARCIES.

 BENCHMARKS ARE PROVIDED FOR THE CONTRACTOR'S CONVENIENCE. IF NEW OR DIFFERENT BENCHMARKS ARE DESIRED, CONTACT THE ENGINEER OR THE SURVEYOR.

 PROTECT EXISTING IMPROVEMENTS INCLUDING UILTHES, STRUCTURES, AND PAVED SURFACES. HARDSCAPE CONSTRUCTION SHALL CONFORM WITH THE TETON COUNTY HIGHWAY & STREET GUIDELINES FOR DESIGN AND CONSTRUCTION (HASCOC) AS WELL AS THE IGAND ONISON OF
- DIVISION 300 . CONCRETE . DIVISION 700 d. AGGREGATES AND ASPHALT. DIVISION 800 . CONSTRUCTION STORMWATER BEST MANAGEMENT PRACTICES. .. DIVISION 1000
 - TRAFFIC CONTROL DIVISION 1100

DWAY GEOMETRICS

- THE PROPOSED ROAD IS A PRIVATELY OWNED LOCAL ROAD SERVING THE SUBDIVISION.
- THE PROPOSED ROAD IS A PRIVATELY OWNED LOCAL ROAD SERVING THE SUBDIVISION.
 STREET AND ROAD RIGHT-OF-WAY AND PAVEMENT WIDTHS SHALL CONFORM TO ALL ADOPTED
 PLANS AND THE RULES OF THE APPROPRIATE DEPARTMENTS HAVING JURISDICTION. RIGHT-OFWAY LINES OF INTERSECTING OR CONNECTING STREETS SHALL BE CONNECTED WITH CURVE
 HAVING A MINIMUM RADUS OF 20-FEET.
 INTERSECTIONS SHALL CONFORM TO THE FOLLOWING REQUIREMENTS:

 a. VERTICAL GRADES. MINIMUM 0.5% MAXIMUM 10%.

 b. ANQLE OF INTERSECTION. STREETS SHALL INTERSECT AT 90 DEGREES OR AS CLOSELY
 THERETO AS POSSIBLE, AND IN NO CASE SHALL STREETS INTERSECT AT LESS THAN 70
 DEGREES.

- SIGHT DISTANCE. MINIMUM CLEAR SIGHT DISTANCE AT ALL MINOR STREET INTERSECTIONS SHALL PERMIT VEHICLES TO BE VISIBLE TO THE DRIVER OF ANOTHER VEHICLE WHEN EACH I 200 FEET FROM THE CENTER OF AN INTERSECTION.

- A FRANCES

 RODOWAY MAN FERMAL SEMAL CONFERM WITH THE TETON COUNTY HIGHWAY AND STREET

 GUIDELIN FOR DESIGN AND CONSTRUCTION HISBODY.

 BUT AND THE MEMBERS HISBODY HISBODY HISBODY HISBODY

 A SAND EDUTAL HISBODY HISBOD

SIEVE SIZE	% PASSING
6-INCH	100
3-INCH	60-100
2-INCH	40-100
1-INCH	30-80
#4	10-40
#200	3-12

b. 2-INCH MINUS: THE MINIMUM SUB-BASE SHALL BE 4 INCHES AFTER COMPACTION, COMPACTED TO 95% OF MAXIMUM DRY DENSITY PER AASHTO T-99 PROCTOR, AND PLACED IN LAYERS NOT MORE THAN 4-INCHES THICK. THE SUB-BASE SHALL MEET THE FOL

SIEVE SIZE	% PASSING
2-1/2-INCH	100
2-INCH	90-100
1-INCH	55-83
#4	30-60
#30	10-25
#200	2-12
#4	30-60
#200	2-12

AGGREGATE BASE COURSE/GRAVEL SURFACE: THE MINIMUM DEPTH SHALL BE 4-INCHES OF CRUSHED AGGREGATE AFTER COMPACTION, COMPACTED TO 95% OF MAXIMUM DRY DENSITY PER AASHTO T-99 PROCTOR AND PLACED IN LAYERS NOT MORE THAN 4-INCHES THICK. THE BASE COURSE SHALL MEET THE FOLLOWING GRADATION:

SIEVE SIZE	% PASSING
3/4-INCH	95-100
3/8-INCH	67-83
#4	48-68
#16	30-45
#40	15-35
#200	10-18

APPROACHES ARE ONTO COUNTY ROADS AND REQUIRE AN APPROVED ENCROACHMENT PERMIT FROM TETON COUNTY

THAT IES

ABOVE-GROUND UTILITIES MUST BE CONSTRUCTED AT LEAST 15 FEET FROM THE SHOULDER OF THE ROAD OR 24 FEET FROM THE CENTERLINE, WHICHEVER IS GREATER AND STILL WITHIN THE ROW.

ALL TRAFFIC CONTROL DEVICES (SIGNING, PAVEMENT MARKINGS, ETC.) SHALL CONFORM TO THE UNIFORM MANUAL OF TRAFFIC CONTROL DEVICES (MUTCD) AS ADOTPED IN IDAHO.

QUALITY CONTROL SHALL BE IN ACCORDANCE WITH DIVISION 2100 OF THE ISPWC

CONSTRUCTION NOTES - APPROACH (ITD STANDARDS)

EARTHWORK SHALL BE PROVIDED AND PERFORMED PER THE ITD 2018 STANDARD SPECIFICATIONS FOR HIGHWAY CONSTRUCTION, DIVISION 200 - EARTHWORK.

- FOR HIGHWAY COMS INCULION, DIVISION 200 EARTHWOME.

 ROSION AND SEDIMENT CONTROL SHALL BE FORVIDED AND PERFORMED PER ITD 2018 STANDARD SPECIFICATIONS FOR HIGHWAY CONSTRUCTION, DIVISION 200 EARTHWORK.

 GRANULAR SUBBASE SHALL BE FURNISHED AND INSTALLED PER ITD 2018 STANDARD SPECIFICATIONS FOR HIGHWAY CONSTRUCTION, DIVISION 301 GRANULAR SUBBASE.
- SPECIFICATIONS FOR HIGHWAY CONSTRUCTION, DIVISION 301 GRANULAR SUBBASE.
 AGGREGATE BASE SHALL BE FURNISHED AND INSTALLED PER ITD 2018 STANDARD SPECIFICATIONS
 FOR HIGHWAY CONSTRUCTION, DIVISION 303 AGGREGATE BASE.
 TRAFFIC CONTROL SHALL BE PERFORMED AND PROVIDED PER ITD 2018 STANDARD
 SPECIFICATIONS FOR HIGHWAY CONSTRUCTION, DIVISION 268 TEMPORARY TRAFFIC CONTROL
 MATERIALS SHALL COMPLY WITH 2018 STANDARD SPECIFICATIONS FOR HIGHWAY CONSTRUCTION,
 DIVISION 700 MATERIALS
- CONSTRUCTION STORMWATER BEST MANAGEMENT PRACTICES SHALL BE PROVIDED AND PERFORMED PER ISPWC DIVISION 1000 CONSTRUCTION STORMWATER BEST MANAGEMENT PRACTICES.

KEYED NOTES

ROADWAY AND PARKING

- UNIDWAY AND PARKING

 FUNNISH AND CONSTRUCT ROADWAY PER TETON COUNTY H&SGDC STANDARD DETAIL (FIGURE 6) FOR MINOR COLLECTOR. TRAVEL LANES SHALL BE 10 FEET WITH 2-FOOT SHOULDERS AND MATERIALS IN ACCORDANCE WITH THE CONSTRUCTION SPECIFICATIONS FOUND HEREIN AND IN THE TETON COUNTY H&SGDC. SEE DETAIL X/C-DT-01
- RESULC. SEC DETAIL AC-01-01
 CONSTRUCT ROUNDABOUT SIMILAR TO CUL-DE-SAC DEPICTED IN FIGURE 3 IN THE TETON COUNTY
 HASGIC AS MODIFIED IN THESE DRAWINGS. SEE DETAIL XC-07-01
 FURNISH MATERIALS AND CONSTRUCT DRIVEWAY PULL-OUT IN ACCORDANCE WITH FIGURE 10 OF THE
 TETON COUNTY HASGIC AS MODIFIED IN THESE DRAWINGS.
- FURNISH AND INSTALL CULVERT PER FIGURE 14 IN THE TETON COUNTY H&SGDC AS MODIFIED IN THESE DRAWINGS
- CONSTRUCT DRAINAGE SWALE AS SHOWN AND IN ACCORDANCE WITH THE GRADING AND DRAINAGE PLAN

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Engineering

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PLAN

HARDSCAPE

SHEET NO: C-101 MARCH 2023

PAGE NO:



C-104 - SIGN AND LANDSCAPING

3-4-2.E.11
ALL SUBDIVISIONS AND PLANNED UNIT DEVELOPMENTS (PUDs) COMPRISING MORE THAN TWO LOTS ON A PRIVATE ROAD ARE REQUIRED TO INSTALL AN ENTRANCE SIGN DISPLAYING THE SUBDIVISION OR PUD NAME. THE NAME MUST BE APPROVED BY THE PLANNING ADMINISTRATOR IN ACCORDANCE WITH THE CURRENT SIGN ORDINANCE REGULATIONS AS OUTLINED IN CHAPTER 9 OF TITLE 8. ADDITIONALLY, ALL ROADS WITHIN THE SUBDIVISION OR PUD MUST BE EQUIPPED WITH STREET SIGNS, AND EVERY DWELLING UNIT MUST BE ASSIGNED AN ADDRESS WITH NUMBERS CLEARLY DISPLAYED IN A VISIBLE LOCATION. (ORD.9 as Amd. through 9-25-2000; Amd.06-05; Amd. 2011-03-17).

- A HIGHWAYS ESTBACKS FROM THE HIGHWAY SHALL BE A MINIMUM OF 50 FEET.

 B. OTHER ROADS: SETBACKS FROM OTHER ROADS SHALL BE A MINIMUM OF 35 FEET FROM THE EDGE
 OF THE ROAD. DISTANCE FROM OTHER SIGNS: SIGNS SHALL NOT BE LOCATED ANY CLOSER THAN 660 HORIZONTA FEET FROM ANY OTHER ADVERTISING SIGN.

ONE ON-PREMISES SIGN, MEASURING 32 SQUARE FEET, PERMANENT, UNLIT, AND USED FOR IDENTIFICATION AND DIRECTIONAL PURPOSES, IS PERMITTED FOR EACH SUBDIVISION.


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PLANTING PLAN

SCALE: NTS

NOTE: PERMANENT, UNLIT 32 SQUARE FEET IDENTIFICATION SIGN ON-PREMISES



SIGN PLAN

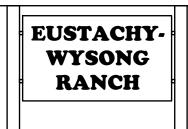

THORNLESS HONEYLOCUST

SIGN AND LANDSCAPING PLAN SHEET NO: C-102

EUSTACHY-WYSONG RANCH

MARCH 2023 PAGE NO:



THE CONTRACTOR SHALL VERIFY ALL DIMENSIONS BEFORE STARTING WORK AND SHALL IMMEDIATELY NOTIFY THE OWNER OF ANY DISCREPANCIES.

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BENCHMARKS ARE PROVIDED FOR THE CONTRACTOR'S CONVINENCE. IF NEW OR DIFFERENT BENCHMARKS ARE DESIRED, CONTACT THE ENGINEER OR THE SURVEYOR.

PROTECT EVISTING IMPROVEMENTS INCLUDING UTILITIES, STRUCTURES, AND PAYED SURFACES. HARDSCAPE CONSTRUCTION SHALL CONFORM WITH THE TETON COUNTY HIGHWAY & STREET GUIDELINES FOR DESIGN AND CONSTRUCTION, HASGOC, AS WELL AS THE IDAHO DIVISON OF PUBLIC WORKS STANDARDS FOR PUBLIC WORKS CONSTRUCTION (EPPC), AS FOLLOWS. IN CASE OF CONFLICT, THE CONSTRUCTION DRAWINGS GOVERN FOLLOWED BY THE TETON COUNTY HASGOC AND THEN THE ISPINC.

ASSIGN AND THEN THE ISPIPIC.

a. EARTHMORK INCLUDING EROSION CONTROL.

b. TRENCHING...

c. CONCRETE...

d. AGGREGATES AND ASPHALT...

e. CONSTRUCTION STORMWATER BEST MANAGEMENT PRACTICES...

f. TRAFFIC CONTROL...

g. MISCELLANEOUS... .. DIVISION 300 ... DIVISION 700

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THE PROPOSEU NUMU IS A PRIVALIELY OWNED LOCAL RUAUS SERVING THE SUBJUVISION.

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INTERSECTIONS SHALL CONFORT TO THE FOLLOWING REQUIREMENTS:

a. VERTICAL GRADES: MINIMUM 55% NAXIMUM 10%.

b. ANGLE OF INTERSECTION STREETS SHALL INTERSECT AT 90 DEGREES OR AS CLOSELY THERETO AS POSSIBLE, AND IN NO CASE SHALL STREETS INTERSECT AT LESS THAN 70 DEGREES.

SIGHT DISTANCE. MINIMUM CLEAR SIGHT DISTANCE AT ALL MINOR STREET INTERSECTIONS SHALL PERMIT VEHICLES TO BE VISIBLE TO THE ORIVER OF ANOTHER VEHICLE WHEN EACH IS 200 FEET FROM THE CENTER OF AN INTERSECTION.

RORUWAN TERMS SHALL CONFORM WITH THE TETON COUNTY HIGHWAY AND STREET GUIDE BEEF OF COSTON AND CONSTRUCTION, HISBORY, SIE BASE: THE INMINIMA SUB-BASE SHALL BE 12.NPCHES OF PIT RUN AFTER COMPACTION W. A SAND EQUIVALETH NOT LESS THAM 30. COMPACTED TO 89% OF MAXIMUM OFF DESITY PER ASSIST

SIEVE SIZE	% PASSING
6-INCH	100
3-INCH	60-100
2-INCH	40-100
1-INCH	30-80
#4	10-40
#200	3-12

SIEVE SIZE	% PASSING
2-1/2-INCH	100
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AGGREGATE BASE COURSE/GRAVEL SURFACE: THE MINIMUM DEPTH SHALL BE 4-INCHES OF CRUSHED AGGREGATE AFTER COMPACTION, COMPACTED TO 95% OF MAXIMUM DRY DENSIT PER AASHTO T-99 PROCOTOR AND PLACED IN LAYERS NOT MORE THAN 4-INCHES THICK. THE BASE COURSE SHALL MEET THE FOLLOWING GRADATION:

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QUALITY CONTROL SHALL BE IN ACCORDANCE WITH DIVISION 2100 OF THE ISPWC

CONSTRUCTION NOTES - APPROACH (ITD STANDARDS)

 EARTHWORK SHALL BE PROVIDED AND PERFORMED PER THE ITD 2018 STANDARD SPECIFICATIONS FOR HIGHWAY CONSTRUCTION. DIVISION 200 - EARTHWORK. FOR HIGHWAY CONSTRUCTION, DIVISION 200 - EARTHWORK.

LEROSION AND SEDIMENT CONTROL SHALL BE PROVIDED AND PERFORMED PER ITD 2018 STANDARD

SPECIFICATIONS FOR HIGHWAY CONSTRUCTION, DIVISION 200 - EARTHWORK.

GRANULAR SIBBASE SHALL BE FURNISHED AND INSTALL ED PER ITD 2018 STANDARD

SPECIFICATIONS FOR HIGHWAY CONSTRUCTION, DIVISION 301 - GRANULAR SUBBASE.

AGGREGATE BASE SHALL BE FURNISHED AND INSTALLED PER ITD 2018 STANDARD SPECIFICATIONS

FOR HIGHWAY CONSTRUCTION, DIVISION 303 - AGGREGATE BASE.

TABLE TO STREAM TO SHALL BE FERFORMED AND PROVIDED FER TID 2018 STANDARD SPECIFICATIONS FOR HIGHWAY CONSTRUCTION, DIVISION 828 – TEMPORARY TRAFFIC C MATERIALS SHALL COMPLY WITH 2018 STANDARD SPECIFICATIONS FOR HIGHWAY CONS

DIVISION / UU - MAI ENIALS

CONSTRUCTION STORMWATER BEST MANAGEMENT PRACTICES SHALL BE PROVIDED AND PERFORMED PER ISPWC DIVISION 1000 CONSTRUCTION STORMWATER BEST MANAGEMENT PRACTICES.

- ROADWAY AND PARKING

 FURNISH AND CONSTRUCT ROADWAY PER TETON COUNTY HASGIC STANDARD DETAIL (FIGURE 6) FOR MINOR COLLECTOR. TRAVEL LANES SHALL BE 10 FEET WITH 2-FOOT SHOULDERS AND MATERIALS IN ACCORDANCE WITH THE CONSTRUCTION SPECIFICATIONS FOUND HEREIN AND IN THE TETON COUNTY HASGIC: SEE DETAIL X-CO-TO
- HASGIC: SEE DETAIL X-CD-T01
 CONSTRUCT ROUNDABOUT SIMILAR TO CUL-DE-SAC DEPICTED IN FIGURE 3 IN THE TETON COUNTY
 HASGIC: AS MODIFIED IN THESE DRAWNIGS. SEE DETAIL X-CD-T01
 FURNISH MATERIALS AND CONSTRUCT DRIVEWAY PULL-0UT IN ACCORDANCE WITH FIGURE 10 OF THE
 TETON COUNTY HASGIC AS MODIFIED IN THISSE DRAWNIGS.
 FURNISH AND INSTALL CULVERT PER FIGURE 1 IN THE TETON COUNTY HASGIC AS MODIFIED IN
- CONSTRUCT DRAINAGE SWALE AS SHOWN AND IN ACCORDANCE WITH THE GRADING AND DRAINAGE PLAN.

HARDSCAPE SITE PLAN

EUSTACHY-WYSONG

Engineering

SHEET NO: DATE: 3/14/24 0

RANCH

EUSTACHY-WYSONG C-103 MARCH 2023 PAGE NO:



C-101 HARDSCAPE PLAN

CONSTRUCTION NOTES

- CONSTRUCTION NOTES

 A. THE CONTRACTOR SHALL VERIFY ALL DIMENSIONS BEFORE STARTING WORK AND SHALL IMMEDIATELY NOTIFY THE OWNER OF ANY DISCREPANCIES.

 B. BENCHMARRIS ARE PROVIDED FOR THE CONTRACTOR'S CONVENIENCE. IF NEW OR DIFFERENT BENCHMARRIS ARE DESIRED, CONTRACT THE SIGNEFOR THE SURVEYOR.

 C. PROTECT EXISTING IMPROVEMENTS INCLUDING UTILLITIES, STRUCTURES, AND PAVED SURFACES.

 D. HARDSCAFE CONSTRUCTION SHALL CONFORM WITH THE TETON COUNTY HIGHMAY & STREET GUIDELINES FOR DESIGN AND CONSTRUCTION (RISPOC) AS WELL AS THE IDAHO DIVISION OF PUBLIC WORKS STANDARDS FOR PUBLIC WORKS CONSTRUCTION (ISPNC) AS FOLLOWS. IN CASE OF CONFLICT, THE CONSTRUCTION DRAWINGS GOVERN FOLLOWED BY THE TETON COUNTY HIGHMAY INCLUDING ENOSITY OF THE PROPERTY OF THE PARK OF THE PROPERTY OF THE PARK OF THE TOWN COUNTY HIGH THE PARK OF THE PAR . DIVISION 300 . DIVISION 700 d. AGGREGATES AND ASPHALT. DIVISION 800 e. CONSTRUCTION STORMWATER BEST MANAGEMENT PRACTICES.....

... DIVISION 1000

... DIVISION 1100 ... DIVISION 2000

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Engineering

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EUSTACHY-WYSONG

DADWAY GEOMETRICS THE PROPOSED ROAD IS A PRIVATELY OWNED LOCAL ROAD SERVING THE SUBDIVISION.

f. TRAFFIC CONTROL...... g. MISCELLANEOUS.....

- THE FINANCIA MADA RIGHT-OF-WAY AND PAVEMENT WIDTHS SHALL CONFORM TO ALL ADD/TED PLANS AND THE RULES OF THE APPROPRIATE DEPARTMENTS HAVING JURISDICTION, RIGHT-OF-HAVING A JURISDICTION, RIGHT-OF-HAVING A JURISDICTION, RIGHT-OF-HAVING A JURISDICTION, RIGHT-OF-HAVING A JURISDICTION OF 20-FEET.

 INTERSECTIONS SHALL CONFORM TO THE FOLLOWING REQUIREMENTS:

 a. VERTICAL GRADES: MINIMUM 0.5%; MAXMUM 10%.

 JANGLE OF INTERSECTION. STREETS SHALL INTERSECT AT 90 DEGREES OR AS CLOSELY THE PROPERTY OF THE PART OF THE PAR

- DEGREES.

 SIGHT DISTANCE. MINIMUM CLEAR SIGHT DISTANCE AT ALL MINOR STREET INTERSECTIONS SHALL PERMIT VEHICLES TO BE VISIBLE TO THE DRIVER OF ANOTHER VEHICLE WHEN EACH IS 200 FEET FROM THE CENTER OF AN INTERSECTION.

- ROADWAY MATERIALS SHALL CONFORM WITH THE TETON COUNTY HIGHWAY AND STREET GUIDELINES FOR DESIGN AND CONSTRUCTION (H&SGDC).
- JOURGEMENT FOR THE MINIMUM SUB-BASE SHALL BE L'INCHES OF PIT RUN AFTER COMPACTION WITH A SAND EQUIVALENT NOT LESS THAN 30, COMPACTED TO 95% OF MAXIMUM DRY DENSITY PER AASHTO T-49 PROCTOR AND PLACED IN LAVERS NOT MORE THAN 6-INCHES THICK. THE SUB-BASE SHALL MEET THE FOLLOWING GRADATION:

SIEVE SIZE	% PASSING
6-INCH	100
3-INCH	60-100
2-INCH	40-100
1-INCH	30-80
#4	10-40
#200	3_12

#200 3-12

b. 2-INCH MINUS: THE MINIMUM SUB-BASE SHALL BE 4 INCHES AFTER COMPACTION, COMPACTED TO 95% OF MANUM DRY DENSITY PER ANSHTO 1-99 PROCTOR, AND PLACED IN LAYERS NOT MORE THAN 4-INCHES THICK: THE SUB-BASE SHALL MEET THE FOLLOWING GRADATION.

SIEVE SIZE	% PASSING
2-1/2-INCH	100
2-INCH	90-100
1-INCH	55-83
#4	30-60
#30	10-25
#200	2-12

AGGREGATE BASE COURSE/GRAVEL SURFACE: THE MINIMUM DEPTH SHALL BE 4-INCHES OF CRUSHED AGGREGATE AFTER COMPACTION, COMPACTED TO 95% OF MAXIMUM DRY DENSITY PER ASSITT O-99 PROCTOR AND PLACED IN LYCER NOT MORE THAN 4-INCHES THICK. THE BASE COURSE SHALL MEET THE FOLLOWING GRADATION:

	SIEVE SIZE	% PASSING
	3/4-INCH	95-100
	3/8-INCH	67-83
i	#4	48-68
	#16	30-45
	#40	15-35
	#200	10-18

APPROACHES ARE ONTO COUNTY ROADS AND REQUIRE AN APPROVED ENCROACHMENT PERMIT FROM TETON COUNTY

ABOVE-GROUND UTILITIES MUST BE CONSTRUCTED AT LEAST 15 FEET FROM THE SHOULDER OF THE ROAD OR 24 FEET FROM THE CENTERLINE, WHICHEVER IS GREATER AND STILL WITHIN THE ROW.

ALL TRAFFIC CONTROL DEVICES (SIGNING, PAVEMENT MARKINGS, ETC.) SHALL CONFORM TO THE UNIFORM MANUAL OF TRAFFIC CONTROL DEVICES (MUTCD) AS ADOTPED IN IDAHO.

L. QUALITY CONTROL SHALL BE IN ACCORDANCE WITH DIVISION 2100 OF THE ISPWC.

CONSTRUCTION NOTES - APPROACH (ITD STANDARDS)

- M. EARTHWORK SHALL BE PROVIDED AND PERFORMED PER THE ITD 2018 STANDARD SPECIFICATIONS FOR HIGHWAY CONSTRUCTION, DIVISION 200 EARTHWORK.

 N. EROSION AND SEDIMENT CONTROL SHALL BE PROVIDED AND PERFORMED PER ITD 2018 STANDARD SPECIFICATIONS FOR HIGHWAY CONSTRUCTION, DIVISION 200 EARTHWORK.

 GRAVILLAR SUBBASE SHALL BE FURNISHED AND INSTALL ED PER ITD 2018 STANDARD SPECIFICATIONS FOR HIGHWAY CONSTRUCTION, DIVISION 201 GRAVILLAR SUBBASE SHALL BE FURNISHED AND INSTALL ED PER ITD 2018 STANDARD SPECIFICATIONS FOR HIGHWAY CONSTRUCTION, DIVISION 301 GRAVILLAR SUBBASE.
- SPECIFICATIONS FOR HIGHWAY CURNISHED AND INSTALLED PERTID 2018 STANDARD SPECIFICATIONS FOR HIGHWAY CONSTRUCTION, DIVISION 303 AGGREGATE BASE.

 TRAFFIC CONTROL SHALL BE PERFORMED AND PROVIDED PER ITD 2018 STANDARD SPECIFICATIONS SPECIFICATIONS FOR HIGHWAY CONSTRUCTION, DIVISION 265 TEMPORARY TRAFFIC CONTROL.
- MATERIALS SHALL COMPLY WITH 2018 STANDARD SPECIFICATIONS FOR HIGHWAY CONSTRUCTION, DIVISION 700 MATERIALS
- DIVISION VIU MATERIALS

 S. CONSTRUCTION STORMWATER BEST MANAGEMENT PRACTICES SHALL BE PROVIDED AND PERFORMED PER ISPWC DIVISION 1000 CONSTRUCTION STORMWATER BEST MANAGEMENT PRACTICES.

KEYED NOTES

ROADWAY AND PARKING

- KUADWAY AND PAKKING

 I. FURNISH AND CONSTRUCT ROADWAY PER TETON COUNTY H&SGDC STANDARD DETAIL (FIGURE 6) FOR MINOR COLLECTOR. TRAVEL LANIES SHALL BE 10 FEEF WITH 2-POOT SHOULDERS AND MATERIALS IN ACCORDING WITH THE CONSTRUCTION SPECIFICATIONS FOUND HEREIN AND IN THE TETON COUNTY H&SGDC. SEE DETAIL XC-DT-01

 CONSTRUCT ROUNDABOUT SIMILAR TO CUL-DE-SAC DEPICTED IN FIGURE 3 IN THE TETON COUNTY H&SGDC AS MODIFIED IN THESE DRAWINGS. SEE DETAIL XC-DT-01

 FURNISH MATERIALS AND CONSTRUCT DRIVEWAY PULL-OUT IN ACCORDANCE WITH FIGURE 10 OF THE TETON COUNTY H&SGDC AS MODIFIED IN THESE DRAWINGS.

- 4. FURNISH AND INSTALL CULVERT PER FIGURE 14 IN THE TETON COUNTY H&SGDC AS MODIFIED IN THESE DRAWINGS

RANCH HARDSCAPE SITE PLAN **EUSTACHY-WYSONG**

C-104





- CONSTRUCTION NOTIES

 GENERAL LOCATION OF UTILITIES IS SHOWN ON THE PLANS. THEY ARE SHOWN FOR GENERAL INFORMATION ONLY AND DO NOT DESIGNATE EXACT UTILITY LOCATIONS. UTILITIES SHOWN MAY NOT BE INCLUSIVE OF ALL UTILIES THAT EXIST.

 IT IS THE CONTRACTOR'S RESPONSIBILITY TO NOTIFY "DIG LINE" PRIOR TO EXCLAYATING AND TO COMPLY WITH IDAPH CODE SECTION 55-220" AND ALL OTHER APPLICABLE LAWS AND REGULATION REGARDING THE PROTECTION OF UNDERGROUND UTILITIES.

- AMINDE TO TILLIII.

 THE CONTRACTOR SHALL NOTIFY ALL CONCERNED UTILITY OFFICES AT LEAST 48 HOURS IN
 DVANCE OF CONSTRUCTION OPERATIONS IN WHICH A UTILITY AGENCY'S FACILITIES MAY BE
- ADVANCE OF CONSTRUCTION OPERATIONS IN WHICH AUTHORISE AND INCOME.

 INCOVIDED THIS SHALL INCLUDE BUT NOT BE LIMITED TO ILLIFATION WATER, CULHARY WATER,
 SANITARY SEWER TELEPHONE, GAS, AND ELECTRIC.

 THE CONTRACTOR SHALL BE RESPONSIBLE FOR ANY AND ALL CHANGES TO, OR RE-CONNECTION

 TO, PUBLIC UTILITY FACILITIES ENCOUNTERED OR INTERRUPTED DURING EXECUTION OF THE

 WORK, AND ALL COSTS RELATED THERETO SHALL BE ROANE BY THE CONTRACTOR

 CONTINUOUS SERVICE—UNLESS OTHERWISE REQUIRED IN THE CONTRACT DOCUMENTS, ALL

 UTILITIES BOTH UNDERGROUND AND OVERHEAD, SHALL BE MAINTAINED IN CONTINUOUS SERVICE

 THROUGHOUT THE ENTITIE CONTRACT PERIOD.

 ACCIDENTAL INTERRUPTION OF SERVICE—IN THE EVENT OF METADURISMS.

- RECONSTRUCTION.
 DIMENSIONS TO, OR COORDINATES FOR, MANHOLES, PIPELINES, ETC. ARE TO CENTERLINE UNLESS OTHERWISE NOTED.
 ELEVATIONS SHOWN ARE TO THE FINISHED SURFACE OR PIPE INVERT UNLESS OTHERWISE NOTED.
 ALL NEW UTILITY LINES ARE TO BE LOCATED AS SHOWN, ON THE PLANS UNLESS RELOCATED IN THE FIELD BY THE ENDINGER TO AVIOID INTERPRENENCE WITH OTHER ASPECTS OF THE PROJECT.
 WHILE GROUNDWATER IS NOT EXPECTED, THE CONTRACTOR SHALL INVESTIGATE GROUNDWATER CONDITIONS PRIOR TO CONSTRUCT IN AND SHALL BE RESPONSIBLE FOR ANY DEWATERING NECESSARY TO CONSTRUCT THE PROJECT.
- M. UTILITY INSTALLATION SHALL CONFORM WITH TETON COUNTY H&SGDC AND WITH THE ISPWC
- EACH LOT WILL HAVE AN INDIVIDUAL SUBSURFACE WASTEWATER DISPOSAL SYSTEM PER DISTRIC
 1 HEALTH DEPARTMENT

BUILDING SEWER	
MATERIAL	PVC SDR 35 OR ABS SCHEDULE 40.
SIZE (MINIMUM)	4 IN
MINIMUM SLOPE	
MAYIMI IM SLODE	1 INCLIDED FOOT 9%

- MAXIMUM SLOPE

 1. INCH PERF P.

 2. ALIONMENT: BUILDING SEWER PIPE SHALL BE LAID IN A STRAIGHT LINE.

 P. CLEANOUTS: CLEANOUTS SHALL BE PLACED AT EVERY CHANGE IN HORZONTAL ALIGNMENT REPAIRS OF REQUAL TO 22. DEGREES AND AT INTERVALS OF UP TO 100 FT IN STRAIGHT RU INCH CAPPED CLEANOUT SHALL BE ENCACED WITHIN FIVE FEET OF THE BUILDING.

 D. BACKFILL: ALL SEWER PIPE PHALL BE INSTALLED ON A FIRM BED, PROTECTED FROM DAMAD TO ROCKS, CLODS, AND DEBRIST THAT MIGHT DAMAGE THE PIPE. THE BACKFILL SHALL BE COMPACTED TO A DENSITY AT LEAST EQUIVALENT TO THE TRENCH WALLS BACKFILL OR INSULATING MATERIAL OVER THE PIPE SHALL BE OF SUFFICIENT DEPTH TO PROTECT THE WASTEWARTER FROM FREEZING AND FROM EXPECTED TRAFFIC LOADS.

	PROPERTY LINES	5 FT.
ю	BUILDING FOUNDATIONS	
	POTABLE WATER PIPES	25 FT.
	SURFACE WATER	50 FT.
8	SETBACKS FOR ABSORPTION SYSTEM	
53	WELLS	100 FT.
89	PROPERTY LINES	
77	BUILDING FOUNDATIONS	
193	POTABLE WATER PIPES	
и.	SEPTIC TANKS	6 FT.
ы	SURFACE WATER	50 FT.
12	GROUNDWATER AND SOILS	
	GROUNDWATER DEPTH (BY EXPLORATION PIT OBSERVED BY HEALTH DEPT.)	
	SOIL TEXTURAL CLASSIFICATION 0-4' BGS (PER DISTRICT 7 HEALTH DEPT.)	A-2b
	CURDED CORRECTION (ONE CURDED CUR)	

 SOIL DESIGN SUBGROUP

 A-2
 B-1
 B-2
 C-1

MODIFIED EFFECTIVE SOIL DEPTH TO IMPERMEABLE LAYER ALLOWED (TO	GM TABLE 2-6)
a. SITE SLOPE SEPTIC SYSTEM, E TO W	109
SITE SLOPE DRAIN FIELD, E TO W	
c. LOT SIZE AREA	<= 1 A
d. POTENTIAL MODIFIED EFFECTIVE DEPTH	4.0 FEET - NO MODIFICAT
EFFECTIVE SEPARATION DISTANCE TO PERMANENT WATER ALLOWED	200 F
 REDUCTION (VERTICAL DISTANCE TO WATER > 25 FEET - NO) 	0 F
i. RESULTING SEPARATION TO PERMANENT WATER	200 F
ii. SEPARATION FOR LINED POND	100 F
CULINARY WATER	

- . EACH STRUCTURE WILL HAVE AN INDIVIDUAL WELL UNDER THE DOMESTIC EXEMPTION ALLOWED BY THE STATE OF IDAHO. PRIVATE UTILITIES
- FALL RIVER ELECTRIC IS THE POWER PROVIDER FOR ELECTRICITY AND WILL DESIGN THE POWER DISTRIBUTION SYSTEM
- GAS WILL BE PROVIDED BY THE INDIVIDUAL HOMEOWNER THROUGH THE INSTALLATION OF A PROPANE TANK.

EUSTACHY-WYSONG RANCH PLAN SITE UTILITY

EUSTACHY-WYSONG

Engineering

SHEET NO: C-105

DATE: MARCH 2023 PAGE NO:



C-103 - GRADING AND DRAINAGE PLAN

CLEARING AND GRUBBING SHALL BE PERFORMED PER TETON COUNTY HIGHWAY AND STREET GUIDELINES FOR DESIGN AND CONSTRUCTION (HASGOC).

EXCAVATION AND EMBANKMENT SHALL BE PERFORMED PER TETON COUNTY HASGOC AND ISPASECTION 202 – EXCAVATION AND EMBANKMENT.

STORM DARIO DESIGN CRITERIA ARE EXTRACTED FROM THE TETON COUNTY DEVELOPMENT CODE. DEISON CRITERIA IS BASED ON THE IDAO TRANSPORTATION DEPARTMENTS PUBLICATION, URBAN STORM SEWER DESIGN FOR DAVID HIGH DEVIAL LATEST EDITION, OR PROCEDURES AS SET FORTH PROFIDED FOR DEVANAGE SYSTEMS SHALL BE AT LEAST TETN (10) YEARS.

SCHOOL OF THE DEAL HAD SHADED SHADE SHADED S

CALCULAI EU FUR THE 25-TEAR, 1-HOUR STORM EVENT.
THE OVERFLOW ROUTE SHALL DIRECT THE 25-VEAR, 24-HOUR POST-DEVELOPMENT FLOW SAFELY
TOWARD THE DOWNSTREAM CONVEYANCE SYSTEM.
TETON COUNTY USES THE 10-VEAR, 24-HOUR EVENT FOR SIZING OF ON-SITE RUNOFF STORAGE
FACILITIES. HOWEVER, THIS PROJECT WILL USE THE 100-YEAR, 24-HOUR STORM TO SIZE THE
RETENTION FACILITIES FOR THE ROJA COW.

DESIGN STORM 10-	YEAR, 24-HOUR.
TOTAL PRECIPITATION DEPTH	1.68"
STORMWATER QUANTITY (RETENTION)	

NOTAL PROGRAMMOGO.

PLAN FOR RETENTION OF TOTAL 100-YEAR, 24-HOUR DESIGN STORM WITH INFILTRATION VIA SHALLOW INJECTION WELLS LOCATED IN EACH OF TWO RETENTION PONDS. ASSUME 50% OF THE STORM VOLUME IS RETAINED IN EACH POND.

TOTAL STORM VOLUME, 100-YEAR, 24-HOUR.

43,890 C.

PORTOGRAMMORE RIMINES CREPICIPIST INJECTION AVERAGE 1% - 3% SLOPE).

0,201

10.77	RETENTION VOLUME PROVIDED	
1560	RETENTION METHOD	ROAD SWALES
5500	REQUIRED RETENTION VOLUME	9,656 CI
-3500	TOTAL STORMWATER RUNOFF, POST-DEVELOPMENT	18,434 CI
325	POST-DEVELOPMENT RUNOFF COEFFICIENT (COMPOSITE)	0.42 If
437	TOTAL STORMWATER RUNOFF, PREDEVELOPMENT	8,778 CI
100	PREDEVELOPMENT RUNOFF COEFFICIENT (VEGETATION, AVERAGE 1% - 3% SLOPE)	0.20 II

Surface Type	AREA (SQUARE FEET)	AREA (ACRES)	PERCENTAGE OF TOTAL	L	RUNOFF COEFFICIENT	RAINFALL (INCHES)	VOLUME (CUBIC FEET)
Pavement, Asphalt	0	0.00	0.0%	Γ	0.95	2.66	9
Pavement, Concrete	0	0.00	0.0%		0.95	2.66	
Pavement, Gravel	0	0.00	0.0%	1	0.75	2.66	
Roofs, Conventional	0	0.00	0.0%	1	0.95	2.66	- 1
Vegetation, Average (1 - 3% slope)	198,000	4.55	100.0%	1	0.20	2.66	8,771
Vegetation, Hilly (3 - 10% slope)	0	0.00	0.0%		0.25	2.66	11
TOTAL	198,000	4.55	100.00%	Γ	0.20	2.66	8,771

		LAND USE DATA				DRAINAGE DATA	
Surface Type	AREA (SQUARE FEET)	AREA (ACRES)	PERCENTAGE OF TOTAL		RUNOFF COEFFICIENT	RAINFALL (INCHES)	VOLUME (CUBIC FEET)
Pavement, Asphalt	0	0.00	0.0%	Г	0.95	2.66	
Pavement, Concrete	0	0.00	0.0%		0.95	2.66	
Pavement, Gravel	79,200	1.82	40.0%		0.75	2.66	13,167
Roofs, Conventional	0	0.00	0.0%		0.95	2.66	(
Vegetation, Average (1 - 3% slope)	118,800	2.73	60.0%		0.20	2.66	5,267
Vegetation, Hilly (3 - 10% slope)	0	0.00	0.0%		0.25	2.66	(
TOTAL	198,000	4.55	100.00%	Г	0.42	2.66	18,434

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EUSTACHY-WYSONG LLC

AND PLAN


EUSTACHY-WYSONG RANCH

GRADING / DRAINAGE !

SHEET NO: C-106 DATE:

PAGE NO:

MARCH 2023

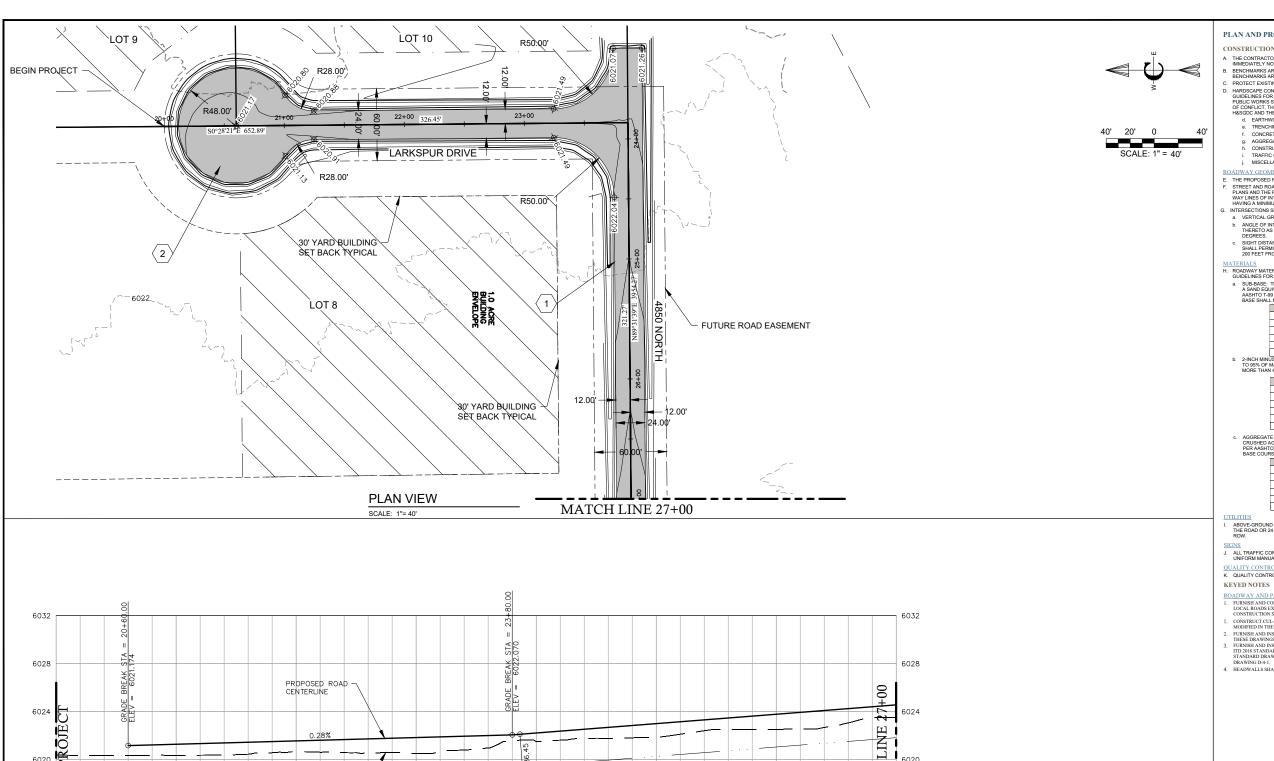

6020

6012

6008

6020 6016

45

24+00

25+00

PROFILE VIEW

SCALE: 1"= 40'

26+00

EXISTING GROUND -

22+00

6020.50 6020.50

23+00

10

6020

6016

6008

21+00

PLAN AND PROFILE SHEETS -GENERAL

CONSTRUCTION NOTES - SUBDIVISION ROADS

CONSTRUCTION NOTES – SUBDIVISION ROADS A. THE CONTRACTOS SHALL VERIEVAL DIMENSIONS BEFORE STARTING WORK AND SHALL IMMEDIATELY MOTIFY THE OWNER OF ANY DISCREPANCIES. BENCHMARKS ARE PROVIDED FOR THE CONTRACTOR'S CONVENIENCE. IF NEW OR DIFFERENT BENCHMARKS ARE DESIRED, CONTACT THE ENGINEER OR THE SURVEYOR. C. PROTECT EXISTING IMPROVEMENTS INCLUDING UTILITIES, STRUCTURES, AND PAVED SURFACES. D. HARDSCAPE CONSTRUCTION SHALL CONFORM WITH THE TETON COUNTY HIGHWAY A STREET GUIDELINES FOR DESIGN AND CONSTRUCTION HASDOOL AS WELL AS THE DAY DIMENSON OF PUBLIC WORKS STANDARDS FOR PUBLIC WORKS CONSTRUCTION (ISPWC) AS FOLLOWS. IN CASE OF CONFLICT, THE CONSTRUCTION DEAVONS GOVERN FOLLOWED BY THE TETON COUNTY HIGHOUS AND THEM THE ISPWC. d. EARTHWORK INCLUDING EROSION CONTROL. DIVISION 300 1. CONCRETE. DIVISION 500 1. CONCRETIE. DIVISION 500 1. TRAFFIC CONTROL. DIVISION 500 1. TRAFFIC CONTROL. DIVISION 1100 1. TRAFFIC CONTROL. DIVISION 1100 1. TRAFFIC CONTROL. DIVISION 1100 1. TRAFFIC CONTROL. DIVISION 2000 ROADWAY OF COMPTICES

- ROADWAY GEOMETRICS

 E. THE PROPOSED ROAD IS A PRIVATELY OWNED LOCAL ROAD SERVING THE SUBDIVISION.

 F. STREET AND ROAD RIGHT-OF-WAY AND PAVEMENT WIDTHS SHALL CONFORM TO ALL ADOPTED PLANS AND THE RULES OF THE APPROPRIATE DEPARTMENTS HAVING JURISIOTION. RIGHT-OF-WAY LINES OF INTERSECTING OR CONNECTING STREETS SHALL BE CONNECTED WITH CURVE HAVING A MINIMUM RADIUS OF 20-FEET.
- INTERSECTIONS SHALL CONFORM TO THE FOLLOWING REQUIREMENTS:

 a. VERTICAL GRADES: MINIMUM 0.5%; MAXIMUM 10%.

- USETTICAL GRADES. MINIMUM 0.5%, MAXIMUM 10%.
 ANGLE OF INTERSECTION. STREETS SHALL INTERSECT AT 90 DEGREES OR AS CLOSELY
 THERETO AS POSSIBLE, AND IN NO CASE SHALL STREETS INTERSECT AT LESS THAN 70
 DEGREES.
 SIGHT DISTANCE. MINIMUM CLEAR SIGHT DISTANCE AT ALL MINOR STREET INTERSECTIONS
 SHALL PERMIT VEHICLES TO SE VISIBLE TO THE DRIVER OF ANOTHER VEHICLE WHEN EACH IS
 200 FEET FROM THE CENTER OF AN INTERSECTION.

- ROADWAY MATERIALS SHALL CONFORM WITH THE TETON COUNTY HIGHWAY AND STREET GUIDELINES FOR DESIGN AND CONSTRUCTION (H&SGDC).
- SUB-BASE: THE MINIMUM SUB-BASE SHALL BE 12-INCHES OF PIT RUN AFTER COMPACTION WI
 A SAND EQUIVALENT NOT LESS THAN 30, COMPACTED TO 95% OF MAXIMUM DRY DENSITY PER
 ASSHOT O-98 PROCTOR AND PLACED IN LAYERS NOT MORE THAN 6-INCHES THICK. THE SUBBASE SHALL MEET THE FOLLOWING GRADATION:

SIEVE SIZE	% PASSING
6-INCH	100
3-INCH	60-100
2-INCH	40-100
1-INCH	30-80
#4	10-40

b. 2-INCH MINUS: THE MINIMUM SUB-BASE SHALL BE 4 INCHES AFTER COMPACTION, COMPACTED TO 95% OF MAXIMUM DRY DENSITY PER AASHTO 1-59 PROCTOR, AND PLACED IN LAYERS NOT MORE THAN 4-INCHES THICK; THE SUB-BASE SHALL MEET THE FOLLOWING GRADATION.

SIEVE SIZE	% PASSING
2-1/2-INCH	100
2-INCH	90-100
1-INCH	55-83
#4	30-60
#30	10-25
#200	2-12

SIEVE SIZE	% PASSING
3/4-INCH	95-100
3/8-INCH	67-83
#4	48-68
#16	30-45
#40	15-35
#200	10-18

ABOVE-GROUND UTILITIES MUST BE CONSTRUCTED AT LEAST 15 FEET FROM THE SHOULDER OF THE ROAD OR 24 FEET FROM THE CENTERLINE, WHICHEVER IS GREATER AND STILL WITHIN THE ROW.

J. ALL TRAFFIC CONTROL DEVICES (SIGNING, PAVEMENT MARKINGS, ETC.) SHALL CONFORM TO THE UNIFORM MANUAL OF TRAFFIC CONTROL DEVICES (MUTCD) AS ADOTPED IN IDAHO.

OUALITY CONTROL

K. QUALITY CONTROL SHALL BE IN ACCORDANCE WITH DIVISION 2100 OF THE ISPWC.

ROADWAY AND PARKING

- FURNISH AND CONSTRUCT ROADWAY PER TETON COUNTY HASGDC STANDARD DETAIL (FIGURE 7) FOR LOCAL ROADS EXCEPT TRAVEL LANE SHALL BE 12 FEET WITH MATERIALS IN ACCORDANCE WITH THE CONSTRUCTION SPECIFICATIONS IN THE TETON COUNTY HASGDC.
- CONSTRUCTION STEELANDSON THE ELECTROCOME
 CONSTRUCT CLUE-ES ACT OF ACCORDANCE WITH FIGURE 3 IN THE TETON COUNTY HASGDC AS MODIFIED IN THESE DRAWINGS.
 FURNISH AND INSTALL CULVERT PER FIGURE 14 IN THE TETON COUNTY HASGDC AS MODIFIED IN THESE DRAWINGS.
- THESE DRAWINGS FURNISH AND INSTALL 40 LF OF 24-INCH DIA. CMP $(2-3.8^{\prime\prime\prime}\times 10^{\prime\prime\prime}\times 3^{\prime\prime\prime}\times 10^{\prime\prime}\times 10^{\prime\prime\prime}$ and and a comparison of the trib 2018 standard specifications for Highway Construction, Division 60 1 -Conduit and Standard Specifications for Highway Construction, Division 60 1 -Conduit and Standard Specific Specifi

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EUSTACHY-WYSONG RANCH

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PAGE NO:

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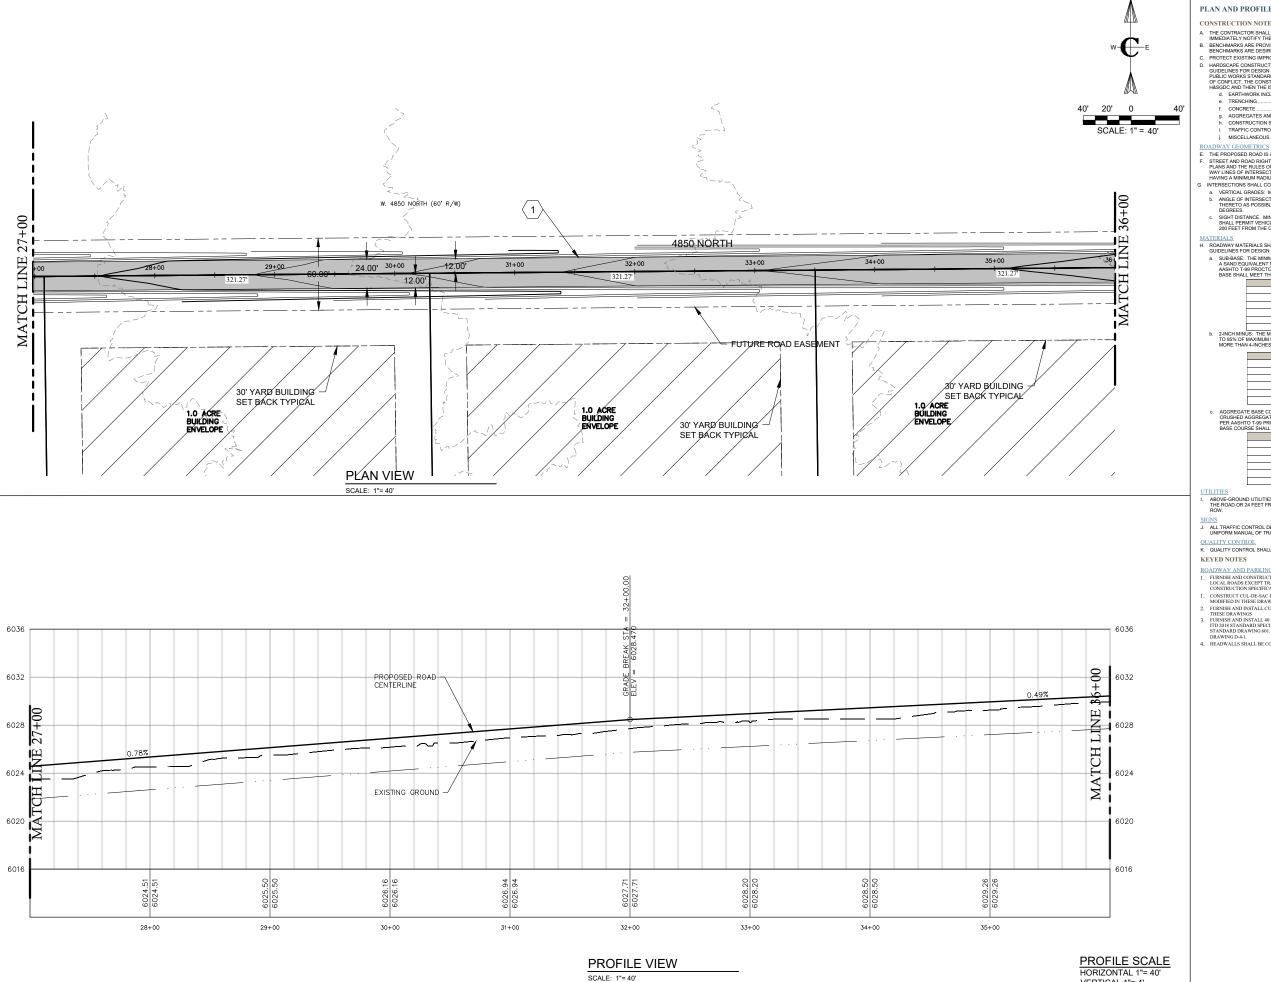
MARCH 2023

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PROFILE SCALE

HORIZONTAL 1"= 40'

VERTICAL 1"= 4'



PLAN AND PROFILE SHEETS -GENERAL

- MMEDIATELY NOTIFY THE OWNER OF ANY DISCREPANCIES.

 BENCHMARKS ARE PROVIDED FOR THE CONTRACTOR'S CONVENIENCE. IF NEW OR DIFFERENT BENCHMARKS ARE DESIRED, CONTACT THE ENGINEER OR THE SURVEYOR.

 PROTECT EXISTING IMPROVEMENTS INCLUDION UTILITIES, STRUCTURES, AND PAVED SURFACES. HARDSCAPE CONSTRUCTION SHALL CONFORM WITH THE TETON COUNTY HIGHWAY & STREET GUIDELINES FOR DESIGN AND CONSTRUCTION HERSOL) AS WELL AS THE IDAN'D DIVISON OF PUBLIC WORKS STANDARDS FOR PUBLIC WORKS CONSTRUCTION (ISPWC) AS FOLLOWS. IN CASE CASE OF THE PUBLIC WORKS CONSTRUCTION (ISPWC) AS FOLLOWS. IN CASE OF THE PUBLIC WORKS CONSTRUCTION (ISPWC) AS FOLLOWS. IN CASE OF THE PUBLIC WORKS CONSTRUCTION (ISPWC) AS FOLLOWS. IN CASE OF THE PUBLIC WORKS CONSTRUCTION (ISPWC) AS FOLLOWS. IN CASE OF THE PUBLIC WORKS CONSTRUCTION (ISPWC) AS FOLLOWS. IN CASE OF THE PUBLIC WORKS CONSTRUCTION (ISPWC) AS FOLLOWS. IN CASE OF THE PUBLIC WORKS CONSTRUCTION (ISPWC) AS FOLLOWS. IN CASE OF THE PUBLIC WORKS CONSTRUCTION (ISPWC) AS FOLLOWS. IN CASE OF THE PUBLIC WORKS CONSTRUCTION (ISPWC) AS FOLLOWS. IN CASE OF THE PUBLIC WORKS CONSTRUCTION (ISPWC) AS FOLLOWS. IN CASE OF THE PUBLIC WORKS CONSTRUCTION (ISPWC) AS FOLLOWS. IN CASE OF THE PUBLIC WORKS CONSTRUCTION (ISPWC) AS FOLLOWS. IN CASE OF THE PUBLIC WORKS CONSTRUCTION (ISPWC) AS FOLLOWS. IN CASE OF THE PUBLIC WORKS CONSTRUCTION (ISPWC) AS FOLLOWS. IN CASE OF THE PUBLIC WORKS CONSTRUCTION (ISPWC) AS FOLLOWS. IN CASE OF THE PUBLIC WORKS CONSTRUCTION (ISPWC) AS FOLLOWS. IN CASE OF THE PUBLIC WORKS CONSTRUCTION (ISPWC) AS FOLLOWS.

	EARTHWORK INCEODING EROSION CONTROL	
e.	TRENCHING	DIVISION 300
f.	CONCRETE	DIVISION 700
g.	AGGREGATES AND ASPHALT	DIVISION 800
h.	CONSTRUCTION STORMWATER BEST MANAGEMENT PRACTICES	DIVISION 1000
i.	TRAFFIC CONTROL	DIVISION 1100

- THE PROPOSED ROAD IS A PRIVATELY OWNED LOCAL ROAD SERVING THE SUBDIVISION
- E. THE PROPOSED ROAD IS A PRIVATELY OWNED LOCAL ROAD SERVING THE SUBDINISION.

 F. STREET AND ROAD RIGHT-OF-WAY AND PAXEMENT WIDTHS SHALL CONFORM TO ALL ADOPTED PLANS AND THE RULES OF THE APPROPRIATE DEPARTMENTS HAVING JURISDICTION. RIGHT-OF-WAY LINES OF INTERSECTION OR CONNECTIONS STREETS SHALL BE CONNECTED WITH CURVE HAVING A MINIMUM RADIUS OF 20-FEET.

 INTERSECTIONS SHALL CONFORM TO THE FOLLOWING REQUIREMENTS:

 a. VERTICAL GRADES: MINIMUM 0.5%: MAXIMUM 10%.

 b. ANGLE OF INTERSECTION. STREETS SHALL INTERSECT AT 90 DEGREES OR AS CLOSELY THERETO AS POSSIBLE, AND IN NO CASE SHALL STREETS INTERSECT AT LESS THAN 70 DEGREES.

 c. SIGHT DISTANCE. MINIMUM CLEAR SIGHT DISTANCE AT ALL MINOR STREET INTERSECTIONS SHALL PREMIT VEHICLES TO DE VISIBLE TO THE ORITIONS SHALL PREMIT VEHICLES TO DE VISIBLE TO THE ORITIONS SHALL PREMIT VEHICLES TO DE VISIBLE TO THE ORITIONS OF THE ORITIONS SHALL PREMIT VEHICLES TO DE VISIBLE TO THE ORITIONS.

- MATERIALS

 I. ROADWAY MATERIALS SHALL CONFORM WITH THE TETON COUNTY HIGHWAY AND STREET
 GUIDELINES FOR DESIGN AND CONSTRUCTION (HASGISC).

 a. SUB-BASE: THE MINIMUM SUB-BASE SHALL BE I'S MICKES OF PIT RUM AFTER COMPACTION WITH
 A SAND ECUIVALENT NOT LESS THAN 30, COMPACTED TO 95% OF MAXIMUM DRY DENSITY PER
 AGHTO 1-99 PROCTOR AND PLACED IN LAVERS NOT MICKE THAN 6-MICHES THICK. THE SUBBASE SHALL MEET THE FOLLOWING GRADITION:

SIEVE SIZE	% PASSING
6-INCH	100
3-INCH	60-100
2-INCH	40-100
1-INCH	30-80
#4	10-40
#200	3-12

b. 2-INCH MINUS: THE MINIMUM SUB-BASE SHALL BE 4 INCHES AFTER COMPACTION, COMPACTED TO 95% OF MAXIMUM DRY DENSITY PER AASHTO T-99 PROCTOR, AND PLACED IN LAYERS NOT MORE THAN 4-INCHES THICK. THE SUB-BASE SHALL MEET THE FOLLOWING GRADATION.

SIEVE SIZE	% PASSING
2-1/2-INCH	100
2-INCH	90-100
1-INCH	55-83
#4	30-60
#30	10-25
#200	2-12

AGGREGATE BASE COURSE/GRAVEL SURFACE: THE MINIMUM DEPTH SHALL BE 4-INCHES OF CRUSHED AGGREGATE AFTER COMPACTION, COMPACTED TO 95% OF MAXIMUM DRY DENSITY PER ASSHTO 7-99 PROCTOR AND PLACED IN LAYERS NOT MORE THAN 4-INCHES THICK. THE BASE COURSE SHALL MEET THE FOLLOWING GRADATION:

URSE SHALL MEET THE FULLOWING GRADATION:		
SIEVE SIZE	% PASSING	
3/4-INCH	95-100	
3/8-INCH	67-83	
#4	48-68	
#16	30-45	
#40	15-35	
#200	10-18	
	SIEVE SIZE 3/4-INCH 3/6-INCH #4 #16 #40	

K. QUALITY CONTROL SHALL BE IN ACCORDANCE WITH DIVISION 2100 OF THE ISPWC.

VERTICAL 1"= 4'

- FURNISH AND CONSTRUCT ROADWAY PER TETON COUNTY H&SGDC STANDARD DETAIL (FIGURE 7) FC LOCAL ROADS EXCEPT TRAVEL LANE SHALL BE 12 FEET WITH MATERIALS IN ACCORDANCE WITH THE CONSTRUCTION SPECIFICATIONS IN THE TETON COUNTY H&SGDC.
- CONSTRUCT CUL-DE-SAC IN ACCORDANCE WITH FIGURE 3 IN THE TETON COUNTY H&SGDC AS MODIFIED IN THESE DRAWINGS.
- SPOURISH AND INSTALL CLUVERT PER FIGURE 14 IN THE TETON COUNTY H&SGIC AS MODIFIED IN THEIR STALL CLUVERT PER FIGURE 14 IN THE TETON COUNTY H&SGIC AS MODIFIED IN THEIR STANDAM ON STALL 40 LF OF 24-IN-CH DIA. CMP (2-3.8" x "" x 3" x 1" ANNULAR CORRUGATIONS) PER TID 2018 STANDARD SPECIFICATION STORE HIGHWAY CONSTRUCTION, DIVISION 601—CONDUIT AND STANDARD SPECIFICATION STANDARD SPECIFICATION STANDARD SPECIFICATION STANDARD SPECIFICATION STANDARD STANDARD SPECIFICATION SPECIFICATION STANDARD SPECIFICATION SPECIFICATION
- 4. HEADWALLS SHALL BE CONSTRUCTED IN ACCORDANCE WITH ITD STANDARD DRAWING 609-

Engineering

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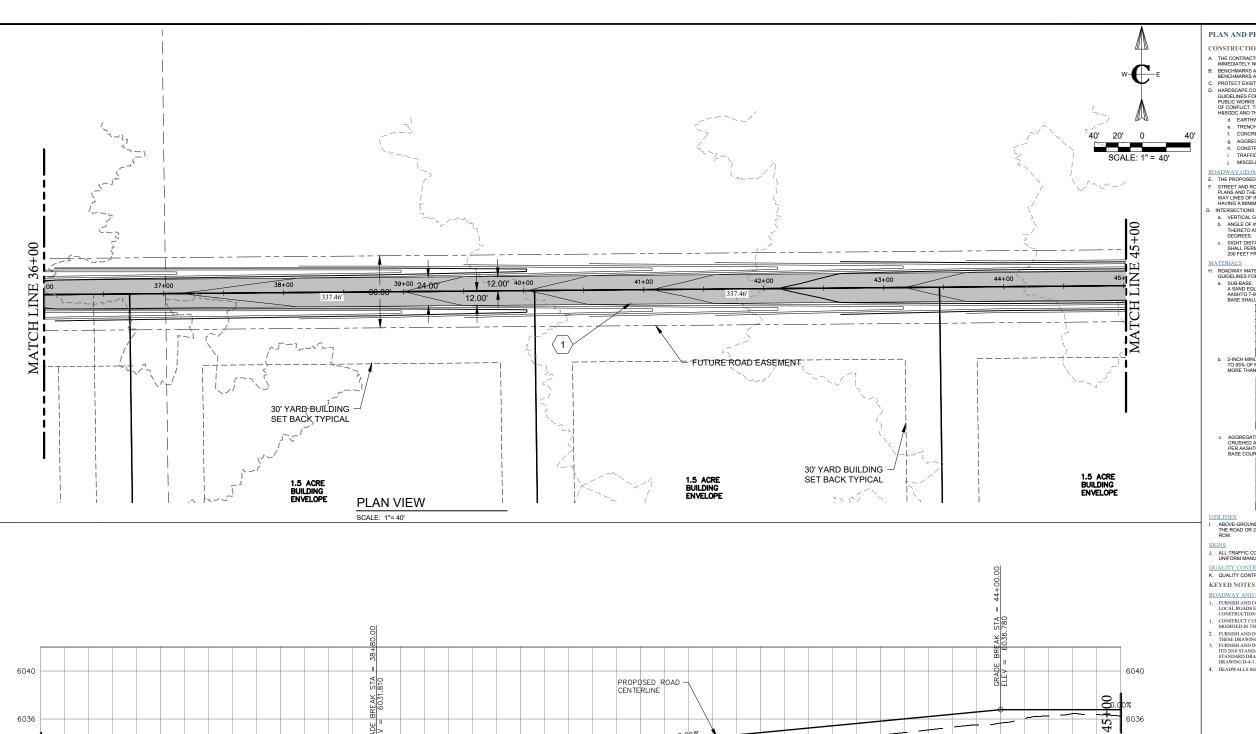
PROFILE AND F PLAN

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PAGE NO:

3/14/24

SHEET NO: C-PP-02 MARCH 2023



EXISTING GROUND +

41+00

PROFILE VIEW

SCALE: 1"= 40'

42+00

43+00

44+00

96

40+00

6032

6028 WATCH 6024

6020

6030.28

37+00

6030.59

38+00

39+00

PLAN AND PROFILE SHEETS -GENERAL

CONSTRUCTION NOTES - SUBDIVISION ROADS

- CONSTRUCTION NOTES SUBDIVISION ROADS

 A THE CONTRACTOR SHALL VERIFY ALL DIMENSIONS BEFORE STARTING WORK AND SHALL
 MIMEDIATELY NOTIFY THE OWNER OF ANY DISCREPANCIES

 BENCHMARKS ARE PROVIDED FOR THE CONTRACTOR'S CONVENIENCE. IF NEW OR DIFFERENT
 BENCHMARKS ARE DESIRED, CONTACT THE ENGINEER OR THE SURVEYOR.

 PROTECT EXISTENCE IMPROVEMENTS INCLUDING UTILITIES, STRUCTURES, AND PAVED SURFACES.

 HARDSCAPE CONSTRUCTION SHALL CONFORM WITH THE TETON COUNTY HIGHWAY & STREET
 GUIDELINES FOR DESIGN AND CONSTRUCTION HEAGON, AS WELL AS THE DIAMP ONLINGON FOR PUBLIC WORKS STANDARDS FOR PUBLIC WORKS CONSTRUCTION (ISPWC) AS FOLLOWS. IN CASE
 OF CONFLICT, THE CONSTRUCTION DRAWINGS GOVERN FOLLOWED BY THE TETON COUNTY
 HASGOC AND THEN THE ISPWC.

 d. EARTHWORK INCLUDING EROSION CONTROL.

 e. TRENCHING

 f. CONGRETE

 DIVISION 300

 f. CONGRETE

 DIVISION 300

 f. CONGRETE

 DIVISION 100

 h. CONSTRUCTION STORMWATER BEST MANAGEMENT PRACTICES.

 DIVISION 100

 IN TAFFIC CONTROL.

 DIVISION 100

 ROADWAY GEOMETRICS

- THE PROPOSED ROAD IS A PRIVATELY OWNED LOCAL ROAD SERVING THE SUBDIVISION.
 - THE PROFUSED ROAD IS A PRIVALIETY OWNED LOCAL ROAD SERVING THE SUBJUVISION.
 STREET AND ROAD RIGHT-OF-WAY AND PAVEMENT WIDTHS SHALL CONFORM TO ALL ADOPTED PLANS AND THE RULES OF THE APPROPRIATE DEPARTMENTS HAVING JURISDICTION. RIGHT-OF-WAY LINES OF INTERSECTING OR CONNECTING STREETS SHALL BE CONNECTED WITH CURVE HAVING A MINIMUM RADIUS OF 20-FEET.
- HAVING A MINIMUM RADIUS OF 20-FEET.

 INTERSECTIONS SHALL CONFORM TO THE FOLLOWING REQUIREMENTS:

 a. VERTICAL GRADES: MINIMUM 0.9%; MAXIMUM 10%.

 b. ANGLE OF INTERSECTION. STREETS SHALL INTERSECT AT 90 DEGREES OR AS CLOSELY THERETO AS POSSIBLE, AND IN NO CASE SHALL STREETS INTERSECT AT LESS THAN 70 DEGREES.

- ATTERIALS

 I. ROADWAY MATERIALS SHALL CONFORM WITH THE TETON COUNTY HIGHWAY AND STREET
 GUIDELINES FOR DESIGN AND CONSTRUCTION (HASGOC).

 SUB-BASE THE MINIMUM SUB-BASE SHALL BE 12 INCHES OF PIT RUN AFTER COMPACTION WITH

 A SAND EQUIVALENT NOT LESS THAN 30, COMPACTED TO 95% OF MAXIMUM DRY DENSITY PER

 ASSHOT OF 9PROCTOR AND PLACED IN LAYERS NOT MORE THAN 6-INCHES THICK. THE SUB
 BASE SHALL MEET THE FOLLOWING GRADATION:

 SIEVE SIZE

 6-NICH

 100

SIEVE SIZE	% PASSING	
6-INCH	100	
3-INCH	60-100	
2-INCH	40-100	
1-INCH	30-80	
#4	10-40	
#200	3-12	

b. 2-INCH MINUS: THE INIMINUS SUB-BASE SHALL BE 4 INCHES AFTER COMPACTION, COMPACTED TO 95% OF MAXIMUM DRY DENSITY PER AASHTO T-99 PROCTOR, AND PLACED IN LAYERS NOT MORE THAN 4 HACHES THICK. THE SUB-BASE SHALL MEET THE FOLLOWING GRADATION.

SIEVE SIZE	% PASSING
2-1/2-INCH	100
2-INCH	90-100
1-INCH	55-83
#4	30-60
#30	10-25
#200	2-12

AGGREGATE BASE COURSE/GRAVEL SURFACE: THE MINIMUM DEPTH SHALL BE 4-INCHES OF CRUSHED AGGREGATE AFTER COMPACTION, COMPACTED TO 65% OF MAXIMUM DRY DENSITY PER ASSHOT 1-09 PROCTOR AND PLACED IN LYERS NOT MORE THAN 4-INCHES THICK. THE BASE COURSE SHALL MEET THE FOLLOWING GRADATION:

SIEVE SIZE	% PASSING
3/4-INCH	95-100
3/8-INCH	67-83
#4	48-68
#16	30-45
#40	15-35
#200	10-18

QUALITY CONTROL

K. QUALITY CONTROL SHALL BE IN ACCORDANCE WITH DIVISION 2100 OF THE ISPWC

6032

6028 6028

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6020

PROFILE SCALE

HORIZONTAL 1"= 40'

VERTICAL 1"= 4'

- RATED WATES

 [RADDWAY AND PARKING]

 [1, FURNISH AND CONSTRUCT ROADWAY FER TETON COUNTY HASGDC STANDARD DETAIL (FIGURE 7) FOR LOCAL ROADS EXCEPT TRAVEL LASE STAILL BE 12 FEET WITH MATERIALS IN ACCORDANCE WITH THE CONSTRUCTION SPECIFICATIONS IN THE TETON COUNTY HASGDC.

 [2] CONSTRUCT CILL-DESAC IN ACCORDANCE WITH FIGURE 3 IN THE TETON COUNTY HASGDC AS MODIFIED IN THESE DRAWNISH.

- THESE DRAWINGS
 FURNISH AND INSTALL 40 LF OF 24-INCH DIA. CMP (2-38" x ½" x 3" x 1" ANNULAR CORRUGA
 FURNISH AND INSTALL 40 LF OF 24-INCH DIA. CMP (2-38" x ½" x 3" x 1" ANNULAR CORRUGA
 FUR 2018 STANDARD SPECIFICATIONS FOR HIGHWAY CONSTRUCTION, DIVISION 601 CONI
 STANDARD DRAWING 601. PIPE SHALL MEET AASHTO M 36 WITH COUPLING BANDS PER IT
 DRAWING 604-10.

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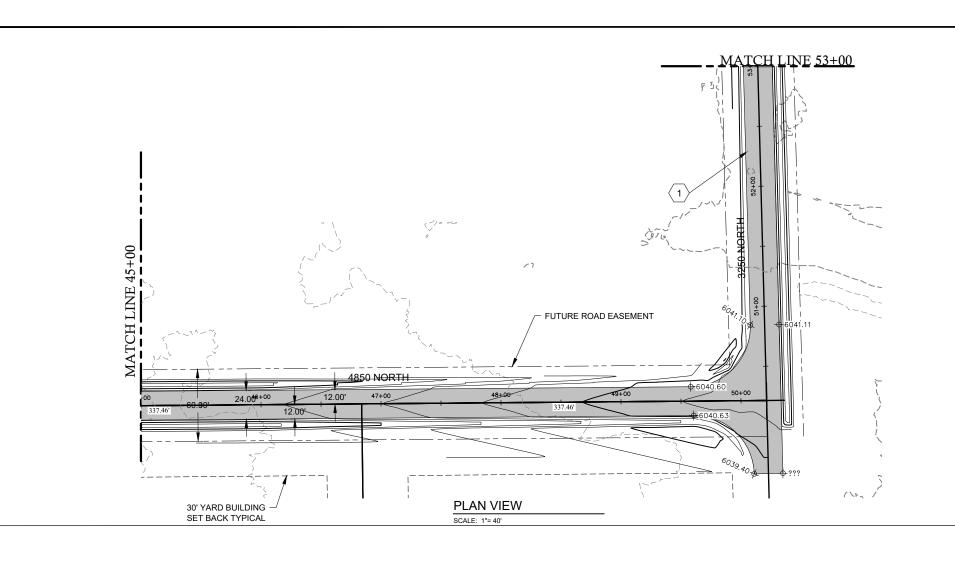
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PROFILE AND PLAN

SHEET NO: C-PP-03 MARCH 2023







CONSTRUCTION NOTES - SUBDIVISION ROADS

- CONSTRUCTION NOTES SUBDIVISION ROADS

 A THE CONTRACTOR SHALL VERIEY ALL DIMENSIONS BEFORE STARTING WORK AND SHALL IMMEDIATELY NOTIFY THE OWNER OF ANY DISCREPANCIES.

 B BENCHMARKS ARE POVIDED FOR THE CONTRACTOR'S CONVENIENCE. IF NEW OR DIFFERENT SENCHMARKS ARE POSITED, CONTACT THE EMBORER OF THE BURYLEYOR.

 PROTECT EXISTING MIRPOVIDENT SHALL CONFORM THE THE TOWN COUNTY HIGHWAY & STREET GUIDEL NES FOR DESIGN AND POVIDENT OF THE TOWN CONTRACTOR'S CONTRACTOR

SCALE: 1" = 40'

- UNDITIVAT GEOMETRICS.

 THE PROPOSED FOAD IS A PRIVATELY OWNED LOCAL ROAD SERVING THE SUBDIVISION.

 STREET AND ROAD RIGHT-OF-WAY AND PAVEMENT WIDTHS SHALL CONFORM TO ALL ADOPTED
 PLANS AND THE RULES OF THE APPROPRIATE DEPARTMENTS HAVING JURISDICTION. RIGHT-OFWAY LINES OF INTERSECTING OR CONNECTING STREETS SHALL BE CONNECTED WITH CURVEHAVING A MINIMUM FADIUS OF 20-FEET.
- HAVING A MINIMUM RADIUS OF 20-FEET.

 INTERSECTIONS SHALL CONFORM TO THE FOLLOWING REQUIREMENTS:

 a. VERTICAL GRADES: MINIMUM 0.5%; MAXIMUM 10%.

 D. ANGLE OF INTERSECTION. STREETS SHALL MITERSECT AT 90 DEGREES OR AS CLOSELY THERETO AS POSSIBLE, AND IN NO CASE SHALL STREETS INTERSECT AT LESS THAN 70 DEGREES.

- ATERIALS

 ROADWAY WATERIALS SHALL CONFORM WITH THE TETON COUNTY HIGHWAY AND STREET GUIDELINES FOR DESIGN AND CONSTRUCTION (HISGOD).

 SUB-BASE THE MINIMUM SUB-BASE SHALL BE 12-INCHES OF PIT RUN AFTER COMPACTION WITH A SAND EQUIVALENT NOT LESS THAN 30, COMPACTED TO 95% OF MAXIMUM DRY DENSITY PER ASSHOT OAS PROCTOR AND FLACED IN LAYERS NOT MORE THAN 6-INCHES THICK. THE SUB-BASE SHALL MEET THE FOLLOWING GRADATION:

SIEVE SIZE	% PASSING
6-INCH	100
3-INCH	60-100
2-INCH	40-100
1-INCH	30-80
#4	10-40
#200	3-12

2-INCH MINUS: THE MINIMUM SUB-BASE SHALL BE 4 INCHES AFTER COMPACTION, COMPACTED TO 95% OF MAXIMUM DRY DENSITY PER ASSHTO T-99 PROCTOR, AND PLACED IN LAYERS NOT MORE THAN 4-INCHES THICK. THE SUB-BASE SHALL MEET THE FOLLOWING GRADATION:

SILVE SIZE	/0 FAGGING
2-1/2-INCH	100
2-INCH	90-100
1-INCH	55-83
#4	30-60
#30	10-25
#200	2-12

AGGREGATE BASE COURSE/GRAVEL SURFACE: THE MINIMUM DEPTH SHALL BE 4-INCHES OF CRUSHED AGGREGATE AFTER COMPACTION, COMPACTED TO 56% OF MAXIMUM DRY DENSITY PER ASSHOT JOS PROCTOR AND PLACED IN LYCERS NOT MORE THAN 4-INCHES THICK. THE BASE COURSE SHALL MEET THE FOLLOWING GRADATION:

SIEVE SIZE	% PASSING
3/4-INCH	95-100
3/8-INCH	67-83
#4	48-68
#16	30-45
#40	15-35
#200	10-18

QUALITY CONTROL

K. QUALITY CONTROL SHALL BE IN ACCORDANCE WITH DIVISION 2100 OF THE ISPWC.

KEYED NOTES

- ROJEWAY AND PARKING

 [] FURNISH AND CONSTRUCT ROADWAY PER TETON COUNTY HASGIC STANDARD DETAIL (FIGURE 7) FOR LOCAL ROADS EXCEPT HRAVEL LANE SHALL BE 12 FEET WITH MATERIALS IN ACCORDANCE WITH THE CONSTRUCTION SPECIFICATIONS IN THE TETON COUNTY HASGIC.

 [] CONSTRUCT CIL-DE-SAC IN ACCORDANCE WITH FIGURE 3 IN THE TETON COUNTY HASGIC AS MODIFIED IN THESE DRAWNISG.

- MODIFIED IN THESE DRAWINGS.

 FURINSH AND INSTALL CULVERT PER FIGURE 14 IN THE TETON COUNTY H&SGDC AS MODIFIED IN THESE DRAWINGS.

 FURINSH AND INSTALL 40 LF OF 24-INCH DIA. CMF (2-3/8" x ½" x 3" x 1" ANNULAR CORRUGATIONS) PER ITD 2018 STANDARD SPECIFICATIONS FOR HIGHWAY CONSTRUCTION, DIVISION 601 CONDUIT AND DEATH OF THE TRANSPORT OF THE TRANS
- HEADWALLS SHALL BE CONSTRUCTED IN ACCORDANCE WITH ITD STANDARD DRA

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Щ PROFILE

EUSTACHY-WYSONG RANCH AND PLAN

C-PP-04

MARCH 2023






PROFILE SCALE

HORIZONTAL 1"= 40'

VERTICAL 1"= 4'






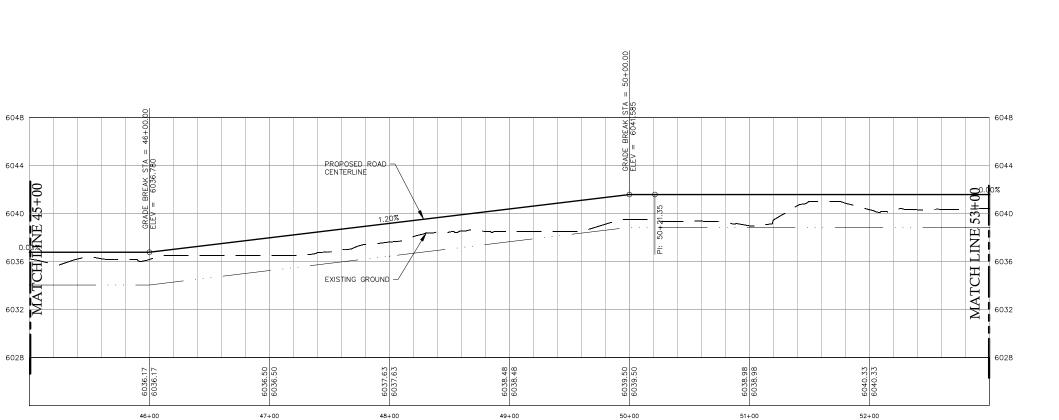

PROFILE VIEW

SCALE: 1"= 40'

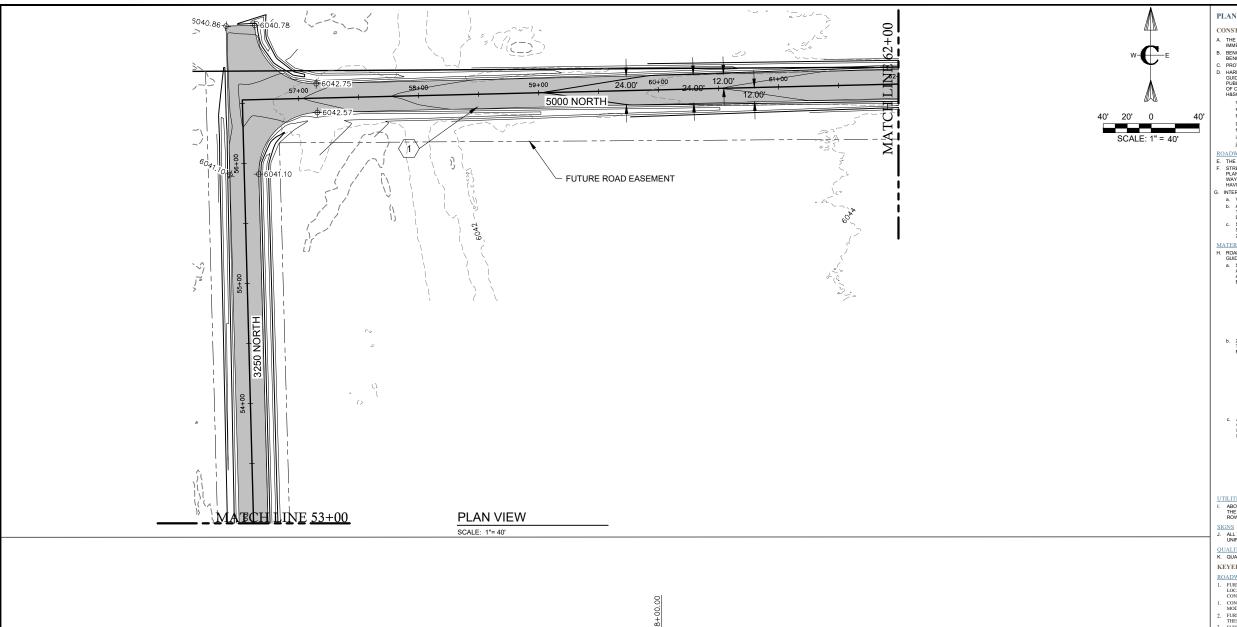

6052 6052 BREAK STA 6044.300 PROPOSED ROAD +000 CENTERLINE 62 6048 6048 GRAD Ż Π 6044 MATCH 6044 1 36% EXISTING GROUND 6040 6040 6036 6036 6032 6032 8 8 6040.53 6040.53 6043.25 6043.25 6043.21 6043.21 6044.04 6041 54+00 55+00 56+00 57+00 58+00 59+00 60+00 61+00

PROFILE VIEW

SCALE: 1"= 40'

PLAN AND PROFILE SHEETS -GENERAL

CONSTRUCTION NOTES - SUBDIVISION ROADS

- . THE CONTRACTOR SHALL VERIFY ALL DIMENSIONS BEFORE STARTING WORK AND SHALL IMMEDIATELY NOTIFY THE OWNER OF ANY DISCREPANCIES.

- MINEDIATE VONTEY THE OWNER OF ANY DISCREPANCIES.

 B. BENCHMARKS ARE PROVIDED FOR THE CONTRACTOR'S CONVENIENCE. IF NEW OR DIFFERENT BENCHMARKS ARE DESIRED, CONTACT THE ANOMERY OR THE SURVEYOR.

 C. PROTECT EXISTING IMPROVEMENTS INCLUDING UTILITIES STRUCTURES, AND PAYED SURFACES.

 D. HARDSCAPE CONSTRUCTION SHALL CONFORM WITH THE TETON COUNTY HIGHWAY & STREET OUTPUT OF A STRUCTURE AS THE DIAHO DYNISON OF CASE.

 OF CONFLICT, THE CONSTRUCTION DRAWINGS GOVERN FOLLOWED BY THE TETON COUNTY HIGHWAY AS STREET OF CONFIDENCE OF CONFLICT, THE CONSTRUCTION DRAWINGS GOVERN FOLLOWED BY THE TETON COUNTY HIGHWAY AS THE STRUCTURE OF CONFIDENCE ON THE CONFIDENCE OF CONFIDE

- OADWAY GEOMETRICS
 THE PROPOSED ROAD IS A PRIVATELY OWNED LOCAL ROAD SERVING THE SUBDIVISION.
 STREET AND ROAD RIGHT-OF-WAY AND PAVEMENT WIDTHS SHALL CONFORM TO ALL ADOPTED
 PLANS AND THE RULES OF THE APPROPRIATE DEPARTMENTS HAVING JURISDICTION. RIGHT-OFWAY LINES OF INTERSECTING OR CONNECTING STREETS SHALL BE CONNECTED WITH CURVE
 HAVING A MINIMUM FADUS OF 20-FEET.

- HAVING A MINIMUM RADIUS OF 29-FEET.

 INTERSECTIONS SHALL CONFORM TO THE FOLLOWING REQUIREMENTS:

 a. VERTICAL GRADES. MINIMUM 0.5%: MAXIMUM 10%.

 JANGLE OF INTERSECTION. STREETS SHALL INTERSECT AT 90 DEGREES OR AS CLOSELY
 THERETO AS POSSIBLE, AND IN NO CASE SHALL STREETS INTERSECT AT LESS THAN 70
 DEGREES.

 c. SIGHT DISTANCE. MINIMUM CLEAR SIGHT DISTANCE AT ALL MINOR STREET INTERSECTIONS
 SHALL PERMIT VEHICLES TO BE VISIBLE TO THE DRIVER OF ANOTHER VEHICLE WHEN EACH IS
 200 FEET FROM THE CENTER OF AN INTERSECTION.

- GUIDELINES FOR DESIGN AND CONSTRUCTION (HASSGUC).

 A SUBBABE: THE MINIMUM USUB-BASE SHALL BE 12-INCHES OF PIT RUN AFTER COMPACTION WIT

 A SAND EQUIVALENT NOT LESS THAN 30, COMPACTED TO 95% OF MAXIMUM DRY DENSITY PER

 ASSHOT 1-39 PROCTOR AND PLACED IN LAYERS NOT MORE THAN 6-INCHES THICK. THE SUB
 BASE SHALL MEET THE FOLLOWING GRADATION:

SIEVE SIZE	% PASSING
6-INCH	100
3-INCH	60-100
2-INCH	40-100
1-INCH	30-80
#4	10-40
#200	3-12

2-INCH MINUS: THE MINIMUM SUB-BASE SHALL BE 4 INCHES AFTER COMPACTION, COMPACTED TO 95% OF MAXIMUM DRY DENSITY PER AASHTO 1-99 PROCTOR, AND PLACED IN LAYERS NOT MORE THAN 4-INCHES THICK. THE SUB-BASE SHALL MEET THE FOLLOWING GRADATION:

SIEVE SIZE	% PASSING
2-1/2-INCH	100
2-INCH	90-100
1-INCH	55-83
#4	30-60
#30	10-25
#200	2-12

AGGREGATE BASE COURSE/GRAVEL SURFACE: THE MINIMUM DEPTH SHALL BE 4-INCHES OF CRUSHED AGGREGATE AFTER COMPACTION, COMPACTED TO 95% OF MAXIMUM DRY DENSITY PER ASSHTO 7-99 PROCTOR AND PLACED IN LAYERS NOT MORE THAN 4-INCHES THICK. THE BASE COURSE SHALL MEET THE FOLLOWING GRADATION:

SIEVE SIZE	% PASSING	
3/4-INCH	95-100	
3/8-INCH	67-83	
#4	48-68	
#16	30-45	
#40	15-35	
#200	10-18	

PROFILE SCALE

HORIZONTAL 1"= 40'

VERTICAL 1"= 4'

ALL TRAFFIC CONTROL DEVICES (SIGNING, PAVEMENT MARKINGS, ETC.) SHALL CONFORM TO THE UNIFORM MANUAL OF TRAFFIC CONTROL DEVICES (MUTCD) AS ADOTPED IN IDAHO.

<u>QUALITY CONTROL</u>

K. QUALITY CONTROL SHALL BE IN ACCORDANCE WITH DIVISION 2100 OF THE ISPWC.

KEYED NOTES ROADWAY AND PARKING

- FURNISH AND CONSTRUCT ROADWAY PER TETON COUNTY H&SGDC STANDARD DETAIL (FIGURE 7) FOR LOCAL ROADS EXCEPT TRAVEL LANG SHALL BE 12 FEET WITH MATERIALS IN ACCORDANCE WITH THE CONSTRUCTION SPECIFICATIONS IN THE TETON COUNTY H&SGDC.

- CONSTRUCT CLUE-BASE IN ACCORDANCE WITH FIGURE 3 IN THE TETON COUNTY HASGDC AS MODIFIED IN THESE DRAWINGS.

 FURNISH AND INSTALL CULVERT PER FIGURE 14 IN THE TETON COUNTY HASGDC AS MODIFIED IN THESE DRAWINGS. HHSSE DRAWINGS FUNNISH AND INSTALL 40 LF OF 24-INCH DIA. CMP (2-3/8" x ½" x 3" x 1" ANNULAR CORRUGATIONS) PER ITD 2018 STANDARD SPECIFICATIONS FOR HIGHWAY CONSTRUCTION, DIVISION 601 – CONDUIT AND STANDARD DRAWING 601. PIDE SHALL MEET AASHTO M 36 WITH COUPLING BANDS PER ITD STANDARD STANDARD DRAWING 601. PIDE SHALL MEET AASHTO M 36 WITH COUPLING BANDS PER ITD STANDARD

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Ш PROFILE **EUSTACHY-WYSONG** AND PLAN


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MARCH 2023





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PLAN AND PROFILE SHEETS -GENERAL

CONSTRUCTION NOTES - SUBDIVISION ROADS

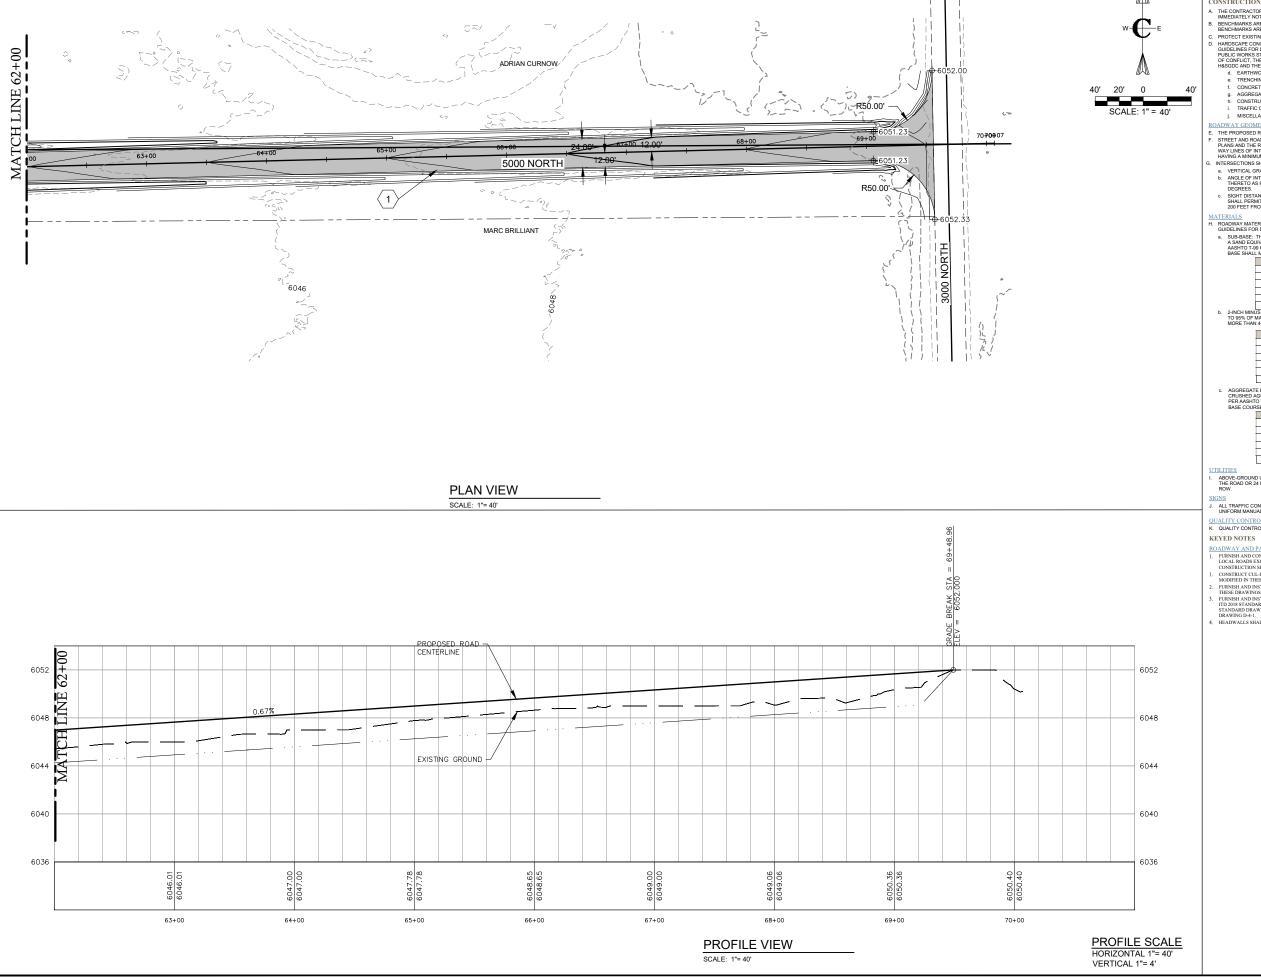. THE CONTRACTOR SHALL VERIFY ALL DIMENSIONS BEFORE STARTING WORK AND SHALL IMMEDIATELY NOTIFY THE OWNER OF ANY DISCREPANCIES.

IMMEDIATELY NOTIFY THE OWNER OF ANY DISCREPANCIES.

BENCHMARKS ARE PROVIDED FOR THE CONTRACTOR'S CONVENIENCE. IF NEW OR DIFFERENT BENCHMARKS ARE DESIRED, CONTACT THE ENGINEER OR THE SURVEYOR.

PROTECT EXISTING IMPROVEMENTS INCLUDING UTILITIES, STRUCTURES, AND PAYED SURFACES.

HARDSCAPE CONSTRUCTION SHALL CONFORM WITH THE TETON COUNTY HIGHWAY & STREET GUIDELINES FOR DESIGN AND CONSTRUCTION, HASGOCJ, AS WELL AS THE IDAHO DIVINOUS PUBLIC WORKS STANDARDS FOR PUBLIC WORKS CONSTRUCTION (ISPNC) AS FOLLOWS. IN CASE OF CONFLICT, THE CONSTRUCTION DRAWNINGS GOVERN FOLLOWS BY THE TETON COUNTY HASGOCJAND THEN THE ISPNC.

H&SGL	C AND THEN THE ISPWC.	
d.	EARTHWORK INCLUDING EROSION CONTROL	DIVISION 200
е.	TRENCHING	DIVISION 300
f.	CONCRETE	DIVISION 700
g.	AGGREGATES AND ASPHALT	DIVISION 800
h.	CONSTRUCTION STORMWATER BEST MANAGEMENT PRACTICES	DIVISION 1000
i.	TRAFFIC CONTROL	DIVISION 1100
j.	MISCELLANEOUS	DIVISION 2000

. THE PROPOSED ROAD IS A PRIVATELY OWNED LOCAL ROAD SERVING THE SUBDIVISION

THE PROPOSED ROAD IS A PRIVATELY OWNED LOCAL ROAD SERVING THE SUBDIVISION.

STREET AND ROAD RIGHT-OF-WAY AND PAYEMENT WIDTHS SHALL CONFORM TO ALL ADOPTED PLANS AND THE RULES OF THE APPROPRIATE DEPARTMENTS HAVING JURISDICTION. RIGHT-OF-WAY LINES OF INTERSECTING OF CONNECTION STREETS SHALL BE CONNECTED WITH CURVE HAVING A MINIMUM RADUS OF 29-FEET.

INTERSECTIONS SHALL CONFORM TO THE FOLLOWING REQUIREMENTS:

a. VERTICAL GRADES: MINIMUM 05% MAXIMUM 10%.

ANGLE OF INTERSECTION. STREETS SHALL INTERSECT AT 90 DEGREES OR AS CLOSELY THERETO AS POSSIBLE, AND IN NO CASE SHALL STREETS INTERSECT AT LESS THAN 70 DEGREES.

NATIONAL MATERIALS SHALL COMEGINA WITH THE TETON COUNTY HIGHWAY AND STREET COMPANY AND ST

SILVE SIZE	/0 FAGGING
6-INCH	100
3-INCH	60-100
2-INCH	40-100
1-INCH	30-80
#4	10-40
#200	3-12

2-INCH MINIÚS: THE MINIMUM SUB-BASE SHALL BE 4 INCHES AFTER COMPACTION, COMPACTED SON OF MAXIMUM DRY DENSITY PER ASSHTO 1-99 PROCTOR. AND PLACED IN LAYERS NOT MORE THAN 4-INCHES THICK. THE SUB-BASE SHALL MEET THE FOLLCWING GRADATION.

SIEVE SIZE	% PASSING
2-1/2-INCH	100
2-INCH	90-100
1-INCH	55-83
#4	30-60
#30	10-25
#200	2-12

AGGREGATE BASE COURSE/GRAVEL SURFACE: THE MINIMUM DEPTH SHALL BE 4-INCHES OF CRUSHED AGGREGATE AFTER COMPACTION, COMPACTED TO 56% OF MAXIMUM DRY DENSITY PER AASHTO 1-09 PROCTOR AND PLACED IN LAYERS NOT MORE THAN 4-INCHES THICK. THE BASE COURSE SHALL MEET THE FOLLOWING GRADATION:

SIEVE SIZE	% PASSING
3/4-INCH	95-100
3/8-INCH	67-83
#4	48-68
#16	30-45
#40	15-35
#200	10-18

RADAWAY AND PARKING

1. FURNISH AND CONSTRUCT BOADWAY PER TETON COUNTY HASGDC STANDARD DETAIL (FIGURE 7) FOR LOCAL ROADS EXCEPT TRAVEL LANE SHALL BE 12 FEET WITH MATERIALS IN ACCORDANCE WITH THE CONSTRUCTION SPECIFICATIONS IN THE TETON COUNTY HASGDC.

1. CONSTRUCT CILL-DE-SAC IN ACCORDANCE WITH FIGURE 3 IN THE TETON COUNTY HASGDC AS MODIFIED IN THESE DRAWNISG.

BROWN LIVE THE ADVANCES.

FURNISH AND INSTALL CULVERT PER FIGURE 14 IN THE TETON COUNTY HASGDC AS MODIFIED IN THESE DIAWNOS.

THESE DIAWNOS.

FURNISH AND INSTALL OLI FOF 2-ARCEL IDA C.MP 62-87 % "", 2" ", 1" ANNILAR CORRUGATIONS PER FIRST STANDED AND ADVANCES OF THE ADV

HEADWALLS SHALL BE CONSTRUCTED IN ACCORDANCE WITH ITD STANDARD DRAWING 609-2

Engineering


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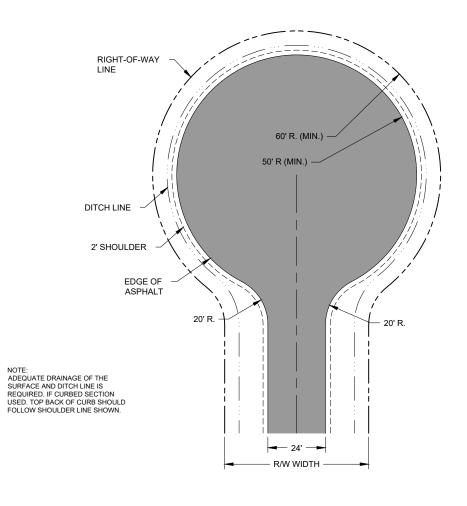
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EUSTACHY-WYSONG RANCH Щ PROFILE AND PLAN

PAGE NO:

SHEET NO: C-PP-06 DATE: MARCH 2023



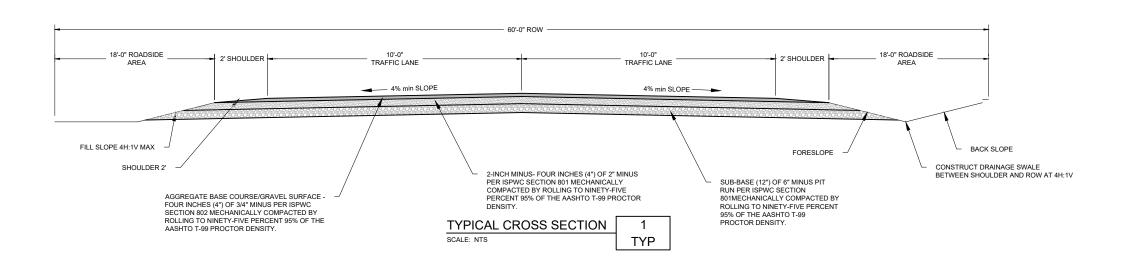


TYPICAL ROUNDABOUT

SCALE: NTS

2

C-PP-3

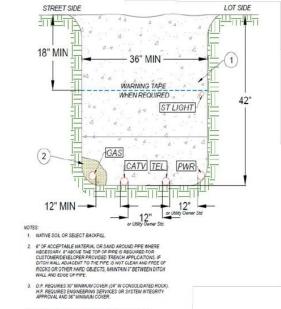

SCALE: NTS

C-PP-4

Brent E Crowther 9500

SHEET NO: C-SD-01 MARCH 2023 PAGE NO:

EUSTACHY-WYSONG RANCH

TYPICAL DETAILS

Civilize, Management an

DOROTHY GAYLE RANCH

GAS MAY BE PLACED ON A LEVEL ABOVE ALL OTHER UTILITIES PROVIDED 12" VERTICAL SEPARATION IS MAINTAINED.

TYPICAL PRIVATE UTILITY TRENCH